SOUTHERN CAYUGA LAKE INTERMUNICIPAL WATER COMMISSION

BOLTON POINT WATER TREATMENT FACILITY ELECTRICAL UPGRADES




CONTRACT NO. 1A - GENERAL CONSTRUCTION CONTRACT NO. 1B - MECHANICAL CONSTRUCTION CONTRACT NO. 1C - ELECTRICAL CONSTRUCTION


SHEET INDEX

	SHEET NO.	SHEET TITLE
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	C101	SITE PLAN
	A001	STANDARD SYMBOLS, NOTES & ABBREVIATIONS
	A002	BUILDING CODE COMPLIANCE REVIEW AND SUMMARY
	A101	EXISTING/DEMOLITION FLOOR PLAN, ELEVATION AND NOTES
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, E	E403	ELECTRICAL DIAGRAMS
L E	E501	ELECTRICAL DETAILS
3	E502	ELECTRICAL SCHEDULES

CITY OF ITHACA TOMPKINS COUNTY, NEW YORK

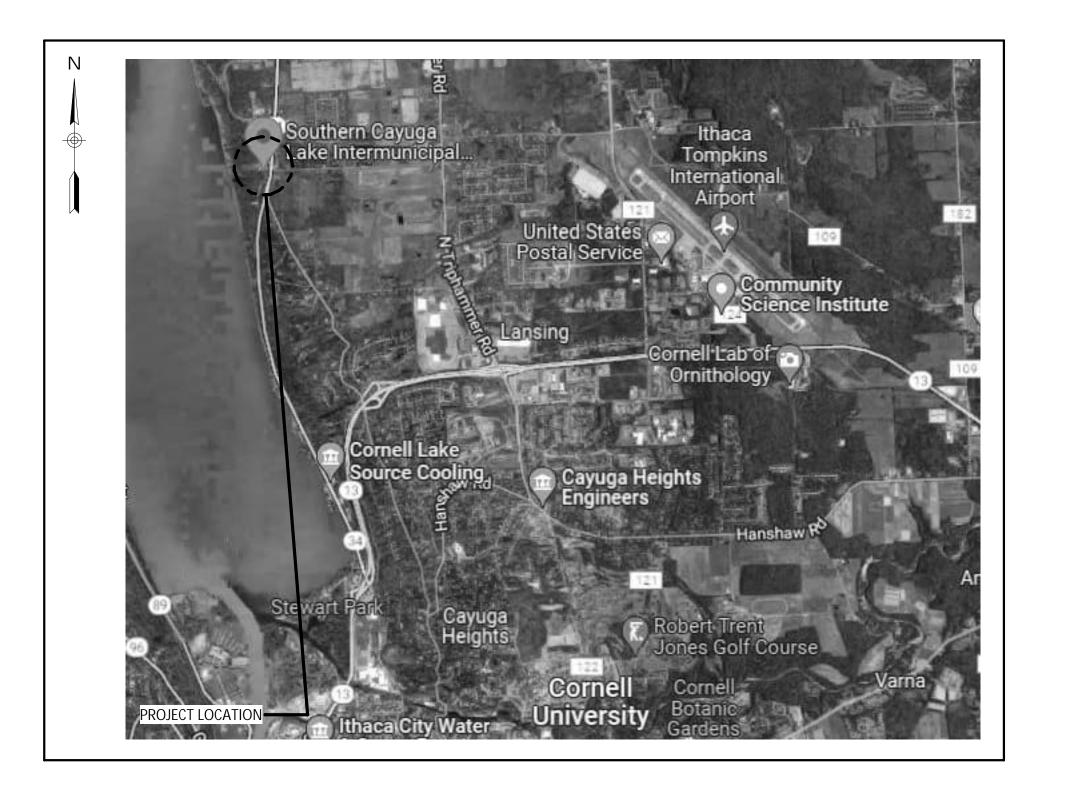


OCTOBER, 2023 CONTRACT DRAWINGS

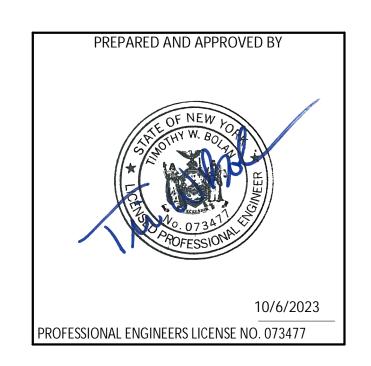

Sheet Number G001

Project Number 677.006.001

IT IS A VIOLATION OF THE NEW YORK STATE EDUCATION LAW, ARTICLE 145 §7209 SPECIAL PROVISIONS, FOR ANY PERSON, UNLESS THEY ARE ACTING UNDER THE DIRECTION OF A LICENSED PROFESSIONAL ENGINEER, ARCHITECT, LANDSCAPE ARCHITECT, OR LAND SURVEYOR, TO ALTER AN ITEM IN ANY WAY. IF AN ITEM BEARING THE STAMP OF A LICENSED PROFESSIONAL IS ALTERED, THE ALTERING PROFESSIONAL SHALL STAMP THE DOCUMENT AND INCLUDE THE NOTATION "ALTERED BY" FOLLOWED BY THEIR SIGNATURE, THE DATE OF SUCH ALTERATION, AND A SPECIFIC DESCRIPTION OF THE ALTERATION.

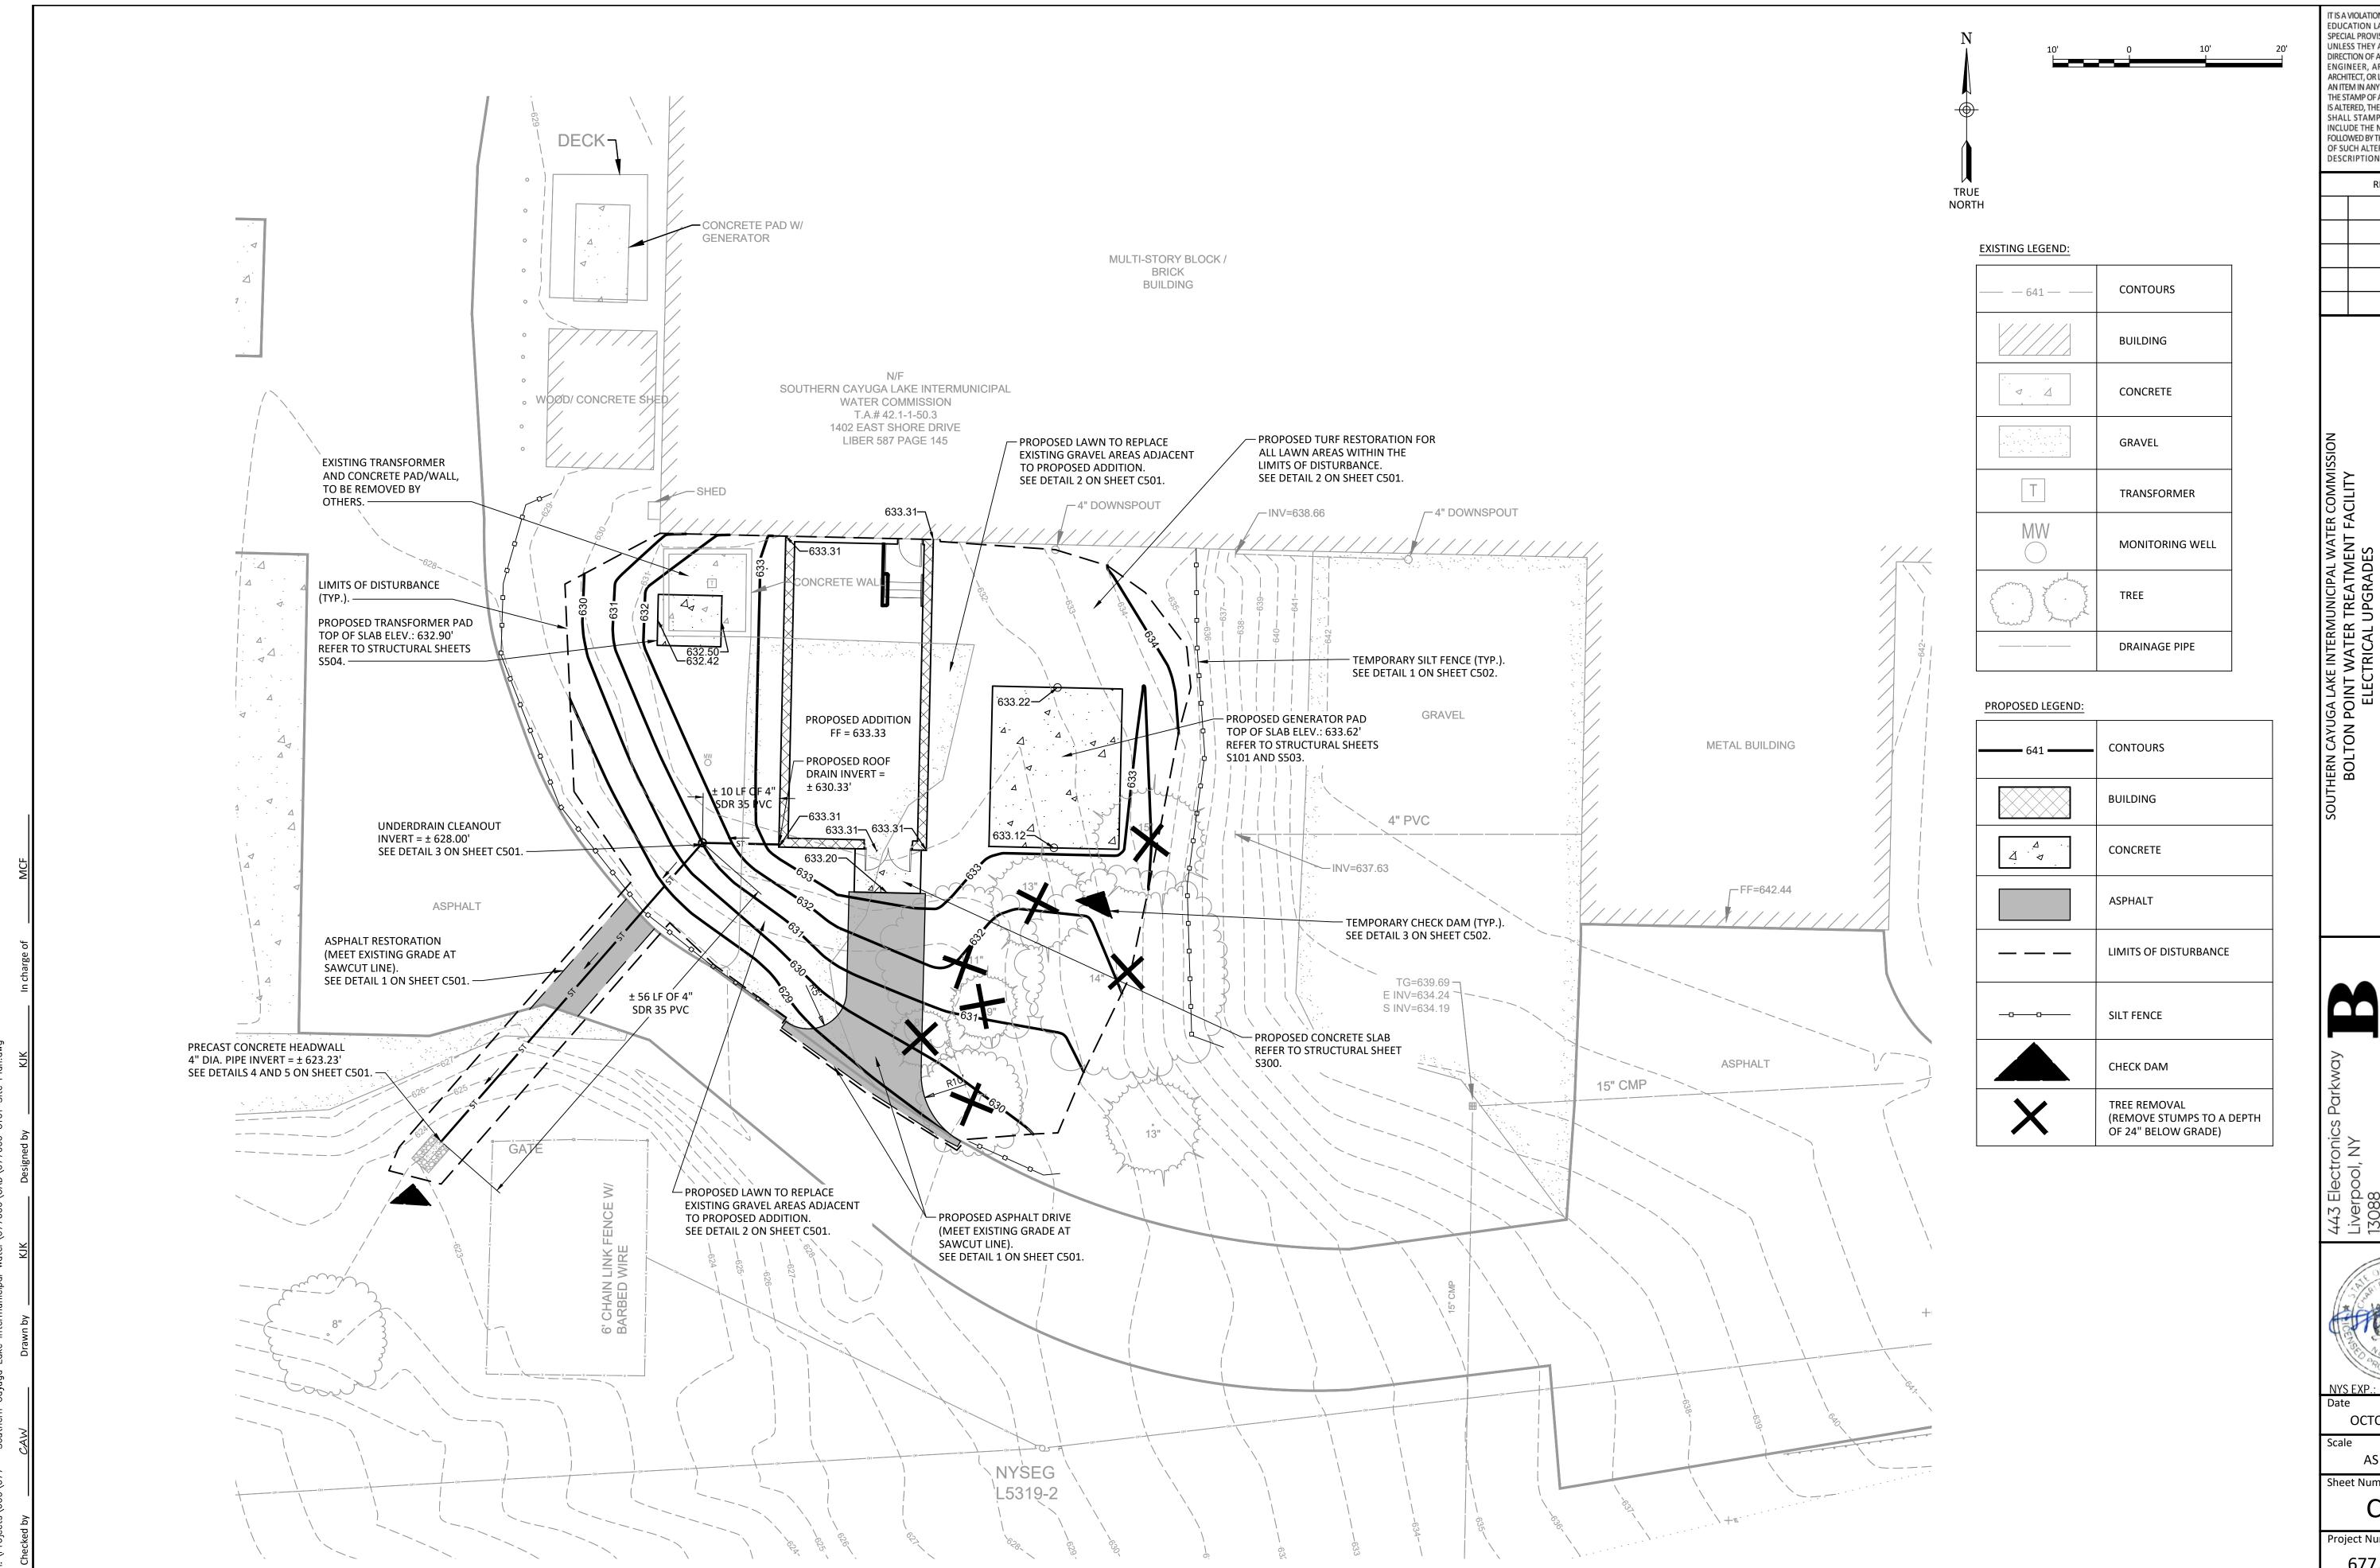

IT IS A VIOLATION OF THE NEW YORK STATE EDUCATION LAW, ARTICLE 145 §7209 SPECIAL PROVISIONS, FOR ANY PERSON, UNLESS THEY ARE ACTING UNDER THE DIRECTION OF A LICENSED PROFESSIONAL ENGINEER, ARCHITECT, LANDSCAPE ARCHITECT, OR LAND SURVEYOR, TO ALTER AN ITEM IN ANY WAY. IF AN ITEM BEARING THE STAMP OF A LICENSED PROFESSIONAL IS ALTERED, THE ALTERING PROFESSIONAL SHALL STAMP THE DOCUMENT AND INCLUDE THE NOTATION "ALTERED BY" FOLLOWED BY THEIR SIGNATURE, THE DATE OF SUCH ALTERATION, AND A SPECIFIC

DESCRIPTION OF THE ALTERATION **REVISIONS**




OCTOBER, 2023

AS SHOWN

Sheet Number C101


1. APPLY DILUTED TACK COAT BETWEEN EACH ASPHALT COURSE AND TO VERTICAL EDGE(S) ABUTTING EXISTING PAVEMENT.



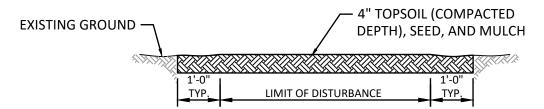


1. TOPSOIL AND SEEDING SHALL BE IN ACCORDANCE WITH SPECIFICATIONS.



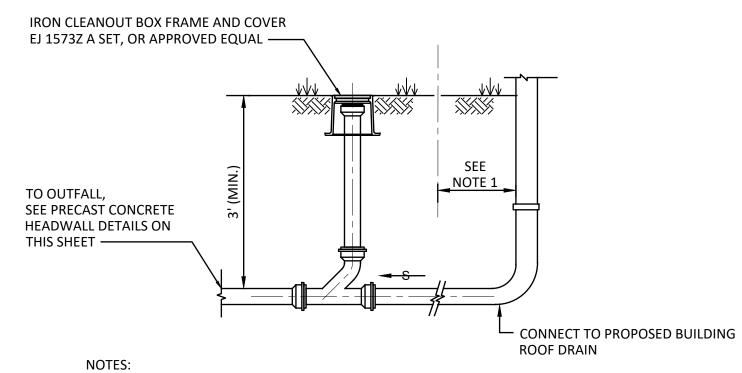


1. CONNECTION TO PROPOSED BUILDING ROOF DRAIN SHALL BE WITHIN 3 FEET OF FACE OF BUILDING, UNLESS OTHERWISE SHOWN/DIRECTED BY THE ENGINEER.



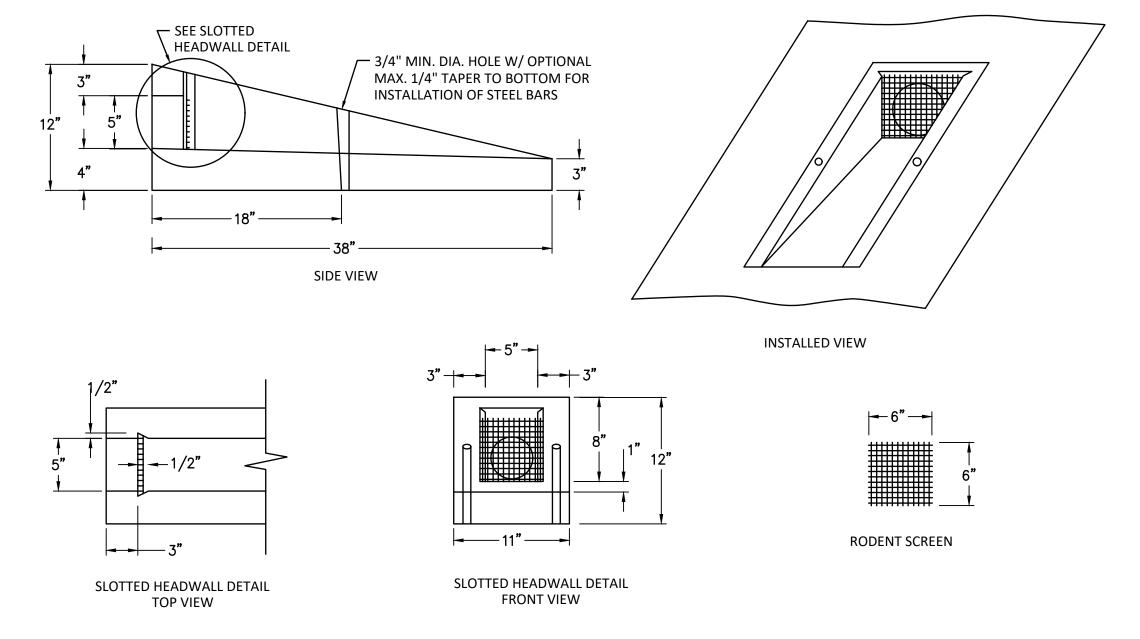

PRECAST CONCRETE HEADWALL FOR 4" LATERAL OUTLET PIPE DETAIL

NOT TO SCALE

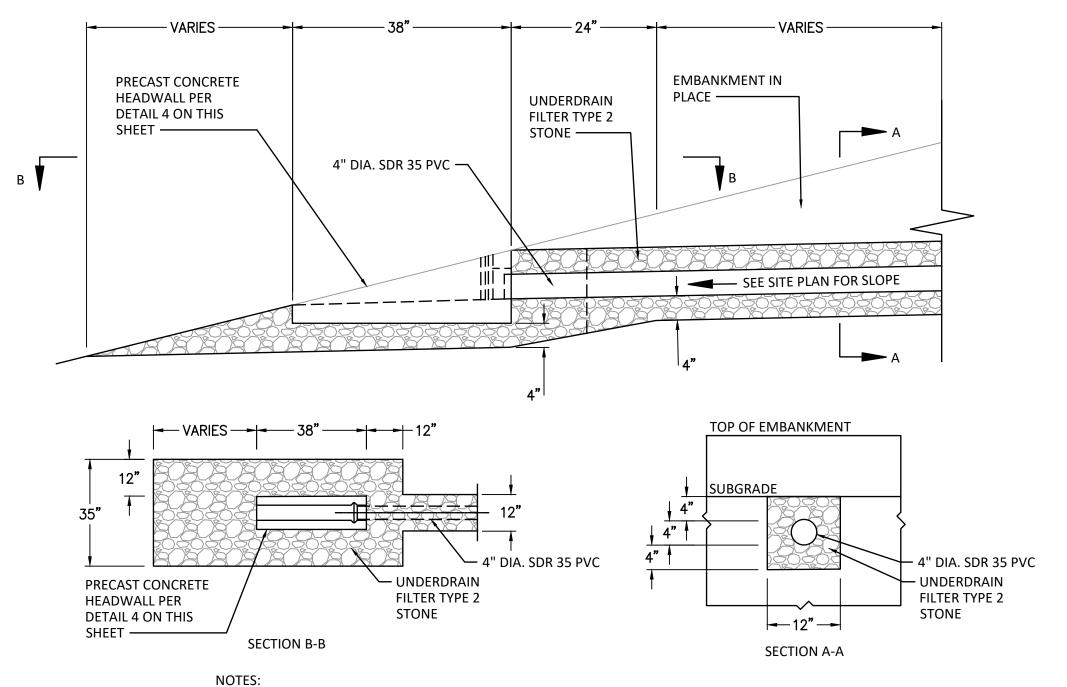

1. LATERAL OUTLET PIPE INVERT PER SITE PLAN.

2. THE GRADE OF THE HEADWALL MAY VARY TO MATCH THE EMBANKMENT SURFACE.

PRECAST CONCRETE HEADWALL FOR 4" LATERAL OUTLET PIPE DETAIL

NOT TO SCALE

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FOLLOWED BY THEIR SIGNATURE, THE DATE OF SUCH ALTERATION, AND A SPECIFIC REVISIONS

OCTOBER, 2023

AS SHOWN Sheet Number


Project Number

CONSTRUCTION NOTES FOR FABRICATED SILT FENCE

- WOVEN WIRE FENCE TO BE FASTENED SECURELY TO FENCE POSTS WITH WIRE TIES OR STAPLES.
- FILTER CLOTH TO BE FASTENED SECURELY TO WOVEN WIRE FENCE WITH TIES SPACED EVERY 24" AT TOP AND MID SECTION.
- WHEN TWO SECTIONS OF FILTER CLOTH ADJOIN EACH OTHER THEY SHALL BE OVERLAPPED BY SIX INCHES AND FOLDED. 4. MAINTENANCE SHALL BE PERFORMED AS NEEDED AND MATERIAL/DEBRIS REMOVED WHEN 'BULGES' DEVELOP IN THE SILT FENCE.
- POSTS: STEEL EITHER "T" OR "U" TYPE OR 2" HARDWOOD. DRIVEN MIN. 16" INTO GROUND.
- FENCE: WOVEN WIRE 14½ GA. 6" MAX. MESH OPENING.
- FILTER FABRIC: FILTER X, MIRAFI 100X, STABLINKA T140N OR APPROVED EQUAL.
- PREFABRICATED UNIT: GEOFAB, ENVIROFENCE, OR APPROVED EQUAL.


TEMPORARY SILT FENCE

NOT TO SCALE

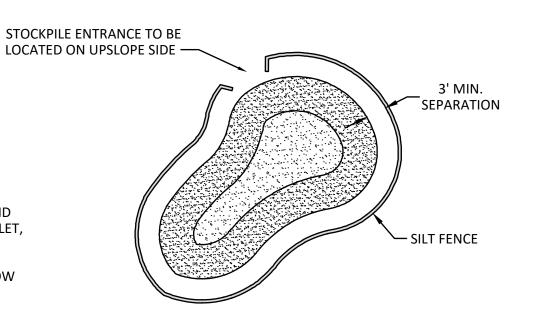


TEMPORARY STOCKPILE NOTES:

- 1. STOCKPILING AREAS SHALL BE DRY, STABLE, AND AT LEAST 50 FEET FROM ANY STORM DRAIN INLET, OPEN CHANNEL, WETLAND, WATERBODY, OR OTHER PROTECTED AREA. DO NOT LOCATE STOCKPILES WITHIN OVERLAND DRAINAGE FLOW PATHS, DESIGNATED FLOODWAYS, OR WITHIN THE DRIP LINE OR OVER THE ROOT CROWN OF ADJACENT TREES. 2. LOCATION FOR STOCKPILING TO BE DETERMINED
- AND APPROVED BY OWNER'S REPRESENTATIVE. THE MAXIMUM SLOPE OF STOCKPILES SHALL BE
- BASED ON THE ANGLE OF REPOSE OF THE STOCKPILED MATERIAL BUT SHALL NEVER BE **GREATER THAN 3:1.** 4. THE MAXIMUM HEIGHT OF STONE STOCKPILE
- SHALL BE 15 FEET.
- 5. UPON COMPLETION OF STOCKPILING EACH PILE SHALL BE SURROUNDED WITH A PERIMETER SEDIMENT CONTROL BARRIER SUCH AS STACKED COMPOST FILTER SOCKS, HAY BALES, OR SILT FENCING.SEE COMPOST FILTER SOCK DETAIL FOR INSTALLATION OF SOCKS. FOR SILT FENCE OR HAY BALES, REFER TO BLUE BOOK FOR INSTALLATION REQUIREMENTS.
- 6. ACCESS TO STOCKPILE SHALL BE READILY AVAILABLE AS NEEDED.

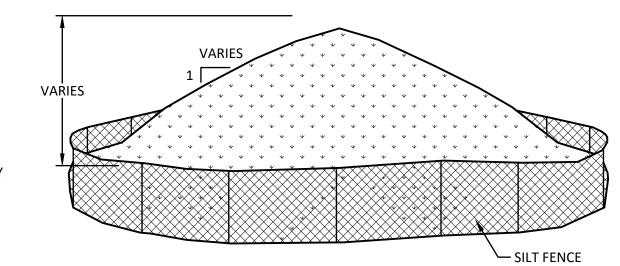

TEMPORARY MATERIAL STOCKPILING



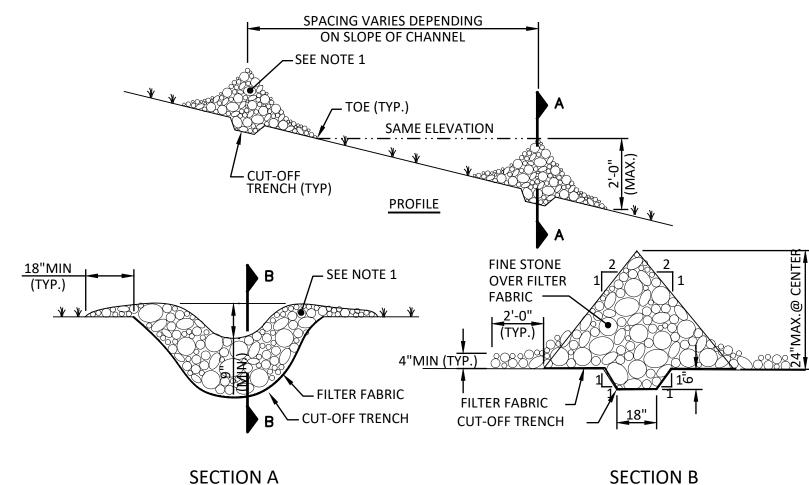


EROSION AND SEDIMENT CONTROL NOTES:

- 1. ALL EROSION AND SEDIMENT CONTROL MEASURES SHALL BE IMPLEMENTED AND MAINTAINED IN CONFORMANCE WITH THE MOST CURRENT REVISION OF THE NEW YORK STATE STANDARDS AND SPECIFICATIONS FOR EROSION AND SEDIMENT CONTROL (THE "BLUE BOOK"). IF FULL IMPLEMENTATION OF THE APPROVED PLAN DOES NOT PROVIDE FOR EFFECTIVE EROSION CONTROL, ADDITIONAL EROSION AND SEDIMENT CONTROL MEASURES SHALL BE IMPLEMENTED TO CONTROL OR TREAT THE SEDIMENT SOURCE. THIS SHALL BE THE
- 2. ANY PROPOSED CHANGES TO THE EROSION AND WATER POLLUTION CONTROL MEASURES SHALL BE APPROVED BY THE ENGINEER PRIOR TO BEING IMPLEMENTED.
- 3. THE SYMBOLS SHOWN ON THE CONSTRUCTION PLAN SHEETS REPRESENT THE EROSION CONTROL ITEMS TO BE USED IN CONJUNCTION WITH THE PROPOSED WORK. THE INSTALLATION METHODS, INCLUDING APPLICABLE PLACEMENT INTERVALS, ARE AS SHOWN ON THE PLANS AND DETAILS IN THE CONTRACT DOCUMENTS.
- 4. THE CONTRACTOR IS ADVISED THAT THE LOCATIONS OF THE TEMPORARY DEVICES ARE APPROXIMATE. THE EXACT DEVICE LOCATIONS TO ACCOMMODATE THE PROPOSED WORK SHALL BE THE CONTRACTOR'S RESPONSIBILITY.
- 5. THE POLLUTION CONTROL NOTES AND DETAILS SHOWN IN THESE DRAWINGS ARE NOT INTENDED TO BE ALL INCLUSIVE BUT TO SERVE AS A GUIDELINE FOR THE DEVELOPMENT OF THE CONTRACTOR'S REQUIRED EROSION CONTROL SCHEME.
- 6. CARE SHALL BE TAKEN TO RETAIN VEGETATION AND PREVENT DAMAGE TO TREES & ORNAMENTAL PLANT MATERIAL WITHIN AND OUTSIDE THE LIMITS OF CONSTRUCTION, AND NOT SCHEDULED FOR REMOVAL. ANY DAMAGE CAUSED TO THIS VEGETATION SHALL BE RESTORED AT THE EXPENSE OF THE CONTRACTOR AS DIRECTED BY THE ENGINEER.

TEMPORARY EROSION AND SEDIMENT CONTROLS

- 1. THE PROPOSED WORK WILL REQUIRE THAT THE TEMPORARY EROSION AND SEDIMENT CONTROLS BE PLACED OVER THE COURSE OF THE PROJECT AS WORK PROGRESSES. NO WORK SHALL BE PERFORMED WITHOUT THE APPROPRIATE CONTROLS ONSITE.
- 2. ALL EROSION AND SEDIMENT CONTROLS SHALL BE PLACED PRIOR TO STARTING EARTHWORK OPERATIONS AND SHALL REMAIN IN PLACE UNTIL THE NEW SLOPES ARE STABILIZED WITH SEEDING AND/OR SLOPE PROTECTION, AND A.O.B.E. STABILIZATION WILL BE CONSIDERED AS 80% COVER, PER SQUARE FOOT, ACROSS THE SITE.
- 3. STREETS/DRIVEWAYS SHALL BE CLEANED DAILY IN A MANNER WHICH WILL MINIMIZE DUST.
- 4. THE CONTRACTOR SHALL FURNISH AND APPLY WATER FOR DUST CONTROL, AS NEEDED. NO SEPARATE PAYMENT FOR DUST CONTROL SHALL BE MADE.
- 5. CONTRACTOR SHALL PROTECT ALL STOCKPILED SOILS WITH APPROPRIATE EROSION AND SEDIMENT CONTROL MEASURES IN ACCORDANCE WITH THE CONTRACT DOCUMENTS.
- 6. THERE ARE NO LOCATIONS WITHIN THE PROJECT LIMITS FOR THE DISPOSAL OF CONSTRUCTION DEBRIS OR SPOILS.

- 1. RESTORE ALL SURFACES TO AS GOOD AS OR BETTER CONDITION THAN BEFORE CONSTRUCTION AS SOON AS POSSIBLE FOLLOWING COMPLETION OF WORK IN ANY AREA.
- 2. UNDER NO CONDITION, SHALL ANY AREA OF UNPROTECTED ERODIBLE EARTH MATERIAL EXPOSED BY CLEARING AND GRUBBING, EXCAVATION, BORROW, OR FILL BE LEFT IN AN UNPROTECTED CONDITION. ANY PORTION OF AN AREA ON WHICH CLEARING AND GRUBBING, EXCAVATION, BORROW, OR FILL HAD PERMANENTLY CEASED SHALL BE STABILIZED, BY EITHER TEMPORARY OR PERMANENT MEANS. THE CONTRACTOR WILL ALSO BE AWARE OF IMPENDING WEATHER CONDITIONS AND THE NEED TO APPLY ROLLED EROSION CONTROL PRODUCT (RECP) AND/OR MULCH ON AREAS THAT WORK IS PROGRESSING.
- 3. IN AREAS WHERE SOIL DISTURBANCE ACTIVITY HAS TEMPORARILY OR PERMANENTLY CEASED, THE APPLICATION OF SOIL STABILIZATION MEASURES MUST BE INITIATED BY THE END OF THE NEXT BUSINESS DAY AND COMPLETED WITHIN FOURTEEN (14) DAYS FROM THE DATE THE CURRENT SOIL DISTURBANCE ACTIVITY CEASED.
- 4. MAINTENANCE OF TEMPORARY SEEDED AREAS SHALL INCLUDE RE-SEEDING AS NEEDED (OR A.O.B.E.) TO ESTABLISH A SATISFACTORY STAND OF TURF. THE COST OF RESEEDING SHALL BE AT THE CONTRACTORS EXPENSE. IT IS HIGHLY RECOMMENDED THAT THE SEEDING BE DONE PRIOR TO INSTALLING THE RECP.
- 5. ALL SLOPES SHALL BE BROUGHT TO FINISHED GRADE AND TRIMMED AS SOON AS POSSIBLE.
- 6. PERMANENT EROSION CONTROL MEASURES OF SEEDING AND MULCHING (SEED ONLY WITHIN SEEDING DATES) SHALL BE CARRIED OUT ONCE THE SLOPES HAVE REACHED FINAL GRADE. TEMPORARY EROSION AND SEDIMENT CONTROL MEASURES AS SHOWN IN THE TEMPORARY SLOPE TREATMENT TABLE SHALL BE EMPLOYED AS INDICATED.
- 7. ALL DISTURBED AREAS WILL BE PERMANENTLY STABILIZED IN ACCORDANCE WITH THE PLANS AND DETAILS IN THE CONTRACT DOCUMENTS. FOR ALL UNPAVED DISTURBED AREAS SPECIFIED OR DIRECTED FOR TURF ESTABLISHMENT, PLACE 4 INCHES OF TOPSOIL AND SEED WITH AN APPROPRIATE PERENNIAL GRASS SEED MIX AND MULCH WITH STRAW. ALL SEED MUST BE PRE-APPROVED BY THE ENGINEER PRIOR TO SEEDING OPERATIONS. MULCH SHALL BE MAINTAINED UNTIL A SUITABLE COVER IS ESTABLISHED.
- 8. FINAL SITE STABILIZATION WILL BE DEFINED AS 80% VEGETATIVE COVER OVER THE ENTIRE SITE. FOLLOWING SITE STABILIZATION, ALL TEMPORARY EROSION AND SEDIMENT CONTROL PRACTICES WILL BE REMOVED SUBJECT TO THE APPROVAL OF THE ENGINEER.

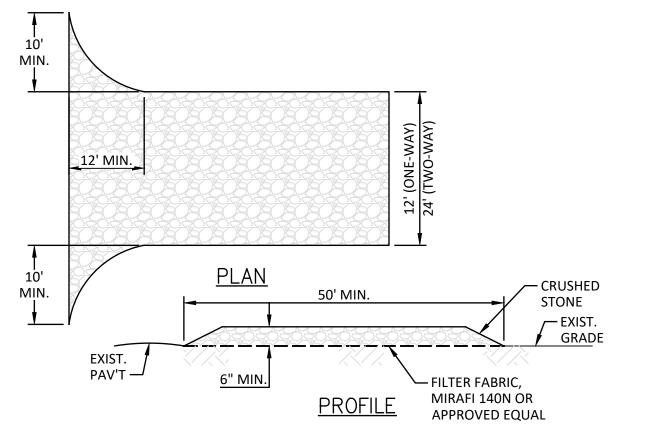


STABILIZED CONSTRUCTION ACCESS NOTES:

- MODIFICATIONS MAY BE REQUIRED TO MEET FIELD CONDITIONS.
- 2. GEOTEXTILE SHALL BE PLACED OVER THE ENTIRE AREA OF STABILIZED CONSTRUCTION ENTRANCE PRIOR TO PLACING STONE. STONE SHALL MEET THE REQUIREMENTS OF NYSDOT ITEM 623.12, CRUSHED NO. 3 STONE.
- 3. ALL SURFACE WATER SHALL BE DIVERTED AWAY FROM CONSTRUCTION ENTRANCE. A MOUNTABLE BERM WITH 5:1 SLOPE IS PERMITTED.
- 4. THE ENTRANCE SHALL BE MAINTAINED IN A CONDITION WHICH WILL PREVENT TRACKING OR FLOWING OF SEDIMENT ONTO PUBLIC RIGHT OF WAY. ALL SEDIMENT SPILLED, DROPPED, WASHED OR TRACKED ONTO PUBLIC RIGHT OF WAY MUST BE REMOVED IMMEDIATELY.
- 5. WHEN WASHING IS REQUIRED, IT SHALL BE DONE ON AN AREA WITH STONE AND WHICH DRAINS
- ONTO AN APPROVED SEDIMENT TRAPPING DEVICE (OR CORRUGATED STEEL PANELS).
- 6. PERIODIC INSPECTION AND NEEDED MAINTENANCE SHALL BE DONE REGULARLY AND FOLLOWING




CONSTRUCTION SPECIFICATIONS FOR STONE CHECK DAM

- FINE STONE WILL BE PLACED ON A FILTER FABRIC FOUNDATION 2' UPSTREAM AND DOWNSTREAM OF TOE TO A MINIMUM (MIN) DEPTH OF 4".
- SET SPACING OF CHECK DAMS SUCH THAT THE ELEVATIONS OF THE CREST OF THE DOWNSTREAM DAM IS AT THE SAME ELEVATION OF THE TOE OF THE UPSTREAM
- EXTEND THE STONE A MINIMUM OF 18" BEYOND THE DITCH BANKS TO PREVENT CUTTING AROUND THE DAM.
- PROTECT THE CHANNEL DOWNSTREAM OF THE LOWEST CHECK DAM FROM SCOUR AND EROSION WITH STONE AND LINER AS DIRECTED BY ENGINEER.
- ENSURE THAT CHANNEL APPURTENANCES SUCH AS CULVERT ENTRANCES BELOW CHECK DAMS ARE NOT SUBJECTED TO DAMAGE OR BLOCKAGE FROM DISPLACED
- MAXIMUM DRAINAGE AREA 2 ACRES.
- PERIODIC INSPECTION AND MAINTENANCE SHALL BE PROVIDED AFTER EACH RAIN

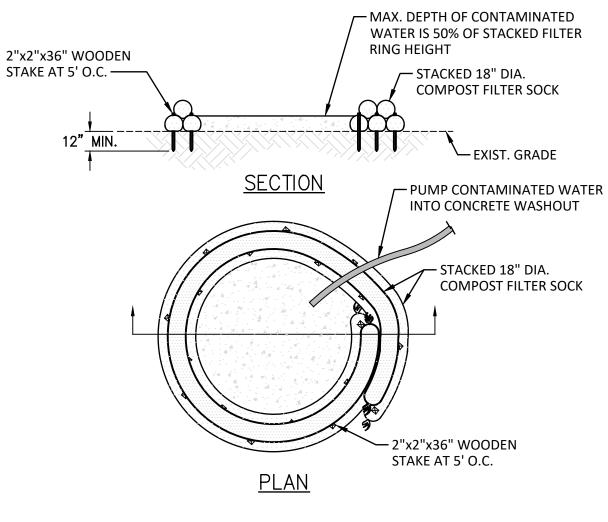

CONCRETE WASHOUT NOTES:

- 1. LOCATE WASHOUT FACILITY ON FLAT GRADE A MINIMUM OF 50 FEET AWAY FROM OPEN CHANNELS, STORM DRAIN INLETS, SENSITIVE AREAS, WETLANDS, BUFFERS AND WATER COURSES AND AWAY FROM CONSTRUCTION TRAFFIC.
- 2. SIZE WASHOUT FACILITY FOR VOLUME NECESSARY TO CONTAIN WASH WATER AND SOLIDS AND MAINTAIN AT LEAST 4 INCHES OF FREEBOARD. TYPICAL DIMENSIONS ARE 10 FEET X 10 FEET X 3 FEET
- 3. COMPOST FILTER SOCKS MAY BE DIRECT SEEDED AT TIME OF INSTALLATION
- 4. PROVIDE A SIGN FOR THE WASHOUT IN CLOSE PROXIMITY TO THE FACILITY.
- 5. INSPECT WASHOUT DAILY. KEEP PRACTICE WATER TIGHT. EMPTY OR REPLACE WASHOUT STRUCTURE THAT IS 50 PERCENT FULL, AND DISPOSE OF ACCUMULATED MATERIAL PROPERLY. DO NOT REUSE COMPOST FILTER SOCKS. WET-VACUUM STORED LIQUIDS THAT HAVE NOT EVAPORATED AND DISPOSE OF IN AN APPROVED MANNER. PRIOR TO FORECASTED RAINSTORMS, REMOVE LIQUIDS OR COVER STRUCTURE TO PREVENT OVERFLOWS. REMOVE HARDENED SOLIDS, WHOLE OR BROKEN UP, FOR DISPOSAL OR RECYCLING. MAINTAIN RUNOFF DIVERSION AROUND EXCAVATED WASHOUT STRUCTURE UNTIL STRUCTURE IS REMOVED.
- 6. ALTERNATIVE CONSTRUCTION USING STRAW BALES AND 10 MIL OR THICKER UV RESISTANT, IMPERMEABLE SHEETING MAY BE APPROVED BY ENGINEER PRIOR TO INSTALLATION

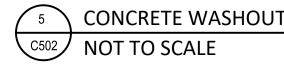

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DESCRIPTION OF THE ALTERATION

REVISIONS

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E INTERM WATER :

OCTOBER, 2023

AS SHOWN Sheet Number

Project Number

677.006.001

TEMPORARY STONE CHECK DAM NOT TO SCALE


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BBR.	DESCRIPTION	ABBR.	STANDARD AB	ABBR.	DESCRIPTION	ABBR.	DESCRIPTION	ABBR.	DESCRIPTION
AD 3 C,AC CMP	ASBESTOS ABATEMENT CONTRACTOR AUTOMATIC AIR DAMPER ANCHOR BOLT AIR CONDITIONING, ALTERNATE CURRENT ASPHALT COATED CORR. METAL PIPE ASBESTOS CONTRAINING MATERIAL	DET DF DH DI DIA DIAG	DETAIL DRINKING FOUNTAIN DOUBLE HUNG DISTILLED WATER, DROP INLET DIAMETER DIAMETER	HT HTG HTR HVAC HVU HVY	HEIGHT HEATING HEATER HEATING/VENT./AIR CONDITIONING HEATING & VENTILATING UNIT HEAVY	RAD RAF RB RC RCP RD	RADIATION RETURN AIR FAN RESILIENT BASE ROOFING CONTRACTOR REINFORCED CONCRETE PIPE ROOF DRAIN	VERT VIF VIN VIT VNR VOL	VERTICAL VERIFY IN FIELD VINYL VITREOUS TILE VENEER VOLUME
))D)H	ASBESTOS CONTAINING MATERIAL ACOUSTIC CEILING SYSTEM AIR CONDITIONING UNIT AREA DRAIN ADDENDUM ADHESIVE ADJACENT, ADJOINING, ADJUSTABLE ACCESS DOOR	DIM DISP DIV DL DMBD DN DO	DIMENSION DISPENSER DIVISION DEAD LOAD DRY MARKER BOARD DOWN DITTO	HWH HWP HWR HWS H&V HV	HOT WATER HOT WATER HEATER HOT WATER PUMP HOT WATER RETURN HOT WATER SUPPLY HEATING AND VENTILATING HIGH VOLTAGE	RECEPT REF REFL REFR REG REINF REM	RECEPTACLE REFERENCE REFLECT (ED) (IVE) (OR) REFRIGERATOR REGISTER REINFORCE (ED) (ING) REMOVE	VTR VWC W W&C WC WD	VENT THROUGH ROOF VINYL WALL COVERING WEST, WATT WIRE AND CONDUIT WATER CLOSET WOOD
ESS F H HU B T	ARCHED EXPOSED STRUCTURAL STEEL ABOVE FINISHED FLOOR ACCESS HATCH AIR HANDLING UNIT AIR INFILTRATION BARRIER AI TERNATE	DP DPR DR DWG DS DT	DAMPROOF (ING) DAMPER DOOR, DEEP RIB, DRAIN DRAWING DOWNSPOUT DRAIN TILE	ID IE IN INCL INS	INSIDE DIAMETER, IDENTIFICATION INVERT ELEVATION INCHES INCLUDE (D) (ING) INSULATE (D) (ING)	REQD RESIL RET REV RFG RFH	REQUIRED RESILIENT RETAINING, RETURN REVISION, REVISED ROOFING ROOF HATCH	WDW WDWC WF WH WI WI	WINDOW
TN UM IP IOD IT	ALTERATION ALUMINUM AMPERE ANODIZED ACID NEUTRALIZING TANK ACCESS POINT	DTA DTL DW DWL DWR	DOVETAIL ANCHOR DETAIL DUMBWAITER, DISHWASHER DOWEL DRAWER	INT INV IP IPS IW	INTERIOR INVERT IRON PIPE IRON PIPE SIZE INDIRECT WASTE	RH RHC RI RL RLG RM	RIGHT HAND REHEAT COIL ROUGH-IN RAIN LEADER RAIL (ING) ROOM	WP WPP WR WS WSCT WT	WATERPROOFING, WORKING WALL PROTECTION PAD WATER REPELLENT, WIDE RIB WATER STOP WAINSCOT WEIGHT
CH B PH V ITO	APPROXIMATE ARCHITECT (URAL) ASBESTOS ASPHALT ATMOSPHERIC VENT AUTOMATIC	E EA EAT EB EC EF	EAST, MODULUS OF ELASTICITY EXHAUST AIR, EACH ENTERING AIR TEMPERATURE EXPANSION BOLT ELECTRICAL CONTRACTOR EACH FACE	JB JC JCT JT	JUNCTION BOX JANITORS CLOSET JUNCTION JOINT KILOWATT (S)	RNT RO ROW RPM RTU RW	RUNNING TRAP ROUGH OPENING RIGHT OF WAY REVOLUTIONS PER MINUTE ROOF TOP UNIT RAW WATER	WWM W/ W/O	WELDED WIRE MESH WITH WITHOUT EXTRA HEAVY CAST IRON
G TR / D	ACID VENT AVERAGE ACID VENT THRU ROOF ACID WASTE BOILER BLOWDOWN	EIFS EJ ELEC ELEV EM ENC	EXTERIOR INSUL. & FINISH SYSTEM EXPANSION JOINT ELECTRIC (AL) ELEVATION EMERGENCY ENCLOSURE	MAN MAS MAT MAU MAX	MANUAL MASONRY MATERIAL MAKE UP AIR UNIT MAXIMUM	S SA SAN SAS	SOUTH SUPPLY AIR SANITARY SMOOTH ALL SIDES	YD	YARD DRAIN, YARD
J P P	BACKDRAFT DAMPER BRICK EXPANSION JOINT BOTTOM OF FOOTING BACK FLOW PREVENTER BOTTOM GRILL BITUMINOUS	EOD EOS EPDM EQ EQC EOUIP	EDGE OF DECK EDGE OF SLAB ETHYLENE PROPYLENE DIENE MONOMER EQUAL EOUIPMENT CONTRACTOR	MBH MBR MD MECH MED ME ME MEMB	THOUSAND BTUH MEMBER MOTORIZED DAMPER MECHANICAL MEDIUM	SEC SGT	SOLID CORE SCHEDULE STRUCTURAL CLAY TILE STORM DRAIN, SLITTER DAMPER, SMOKE DAMPER SECTION STRUCTURAL GLAZED TILE		
DG K KG 1	BUILDING BLOCK BLOCKING BEAM BY OTHERS BOTTOM OF CURB	ESF ESM ETR EW EWC EWT	EOUIPMENT ELASTIC SHEET FLASHING ELASTIC SHEET MEMBRANE EXISTING TO REMAIN EACH WAY ELECTRIC WATER COOLER ENTERING WATER TEMPERATURE	MEZZ MF MFLP MFR MH	MEMBRANE MEZZANINE MIXING FAUCET, METAL FRAMING METAL FURRING LATH & PLASTER MANUFACTURE (ER) MANHOLE	SH SHR SHTNG SIM SK SL	SHELF, SHELVING, SMOKE HATCH SHOWER SHEATHING SIMILAR SINK		
D T L DG G	BOTTOM OF DUCT BOTTOM BEARING PLATE BOTTOM REGISTER BRIDGING BEARING	EXH EXG EXP EXT	EXHAUST EXISTING EXPANSION EXTERIOR, EXTERNAL FAHRENHEIT	MIN MIR MISC MO MOD MR	MINIMUM MIRROR MISCELLANEOUS MASONRY OPENING MODULE (OR), MODEL MOP RECEPTOR	SLB SLC SLV SLVR SP SPEC	SOUND LINED, SKYLIGHT STEEL ANGLE BASE SILL COCK SLEEVE STORM LOUVER STATIC PRESSURE, STANDPIPE SPECIFICATION (S)		
K Z MT	BRICK BRONZE BOTH SIDES BASEMENT BACKSPLASH	FAC FAI FCU FD FDC	FIRE ALARM FACTORY FINISH FRESH AIR INTAKE FAN COOL UNIT FLOOR DRAIN, FIRE DAMPER FIRE DEPARTMENT CONNECTION	MTD MTG MTL MTH MTR	MOUNT MOUNTED MOUNTING METAL MARBLE THRESHOLD METER	SPKR SPL SQ SS SST ST	SPRINKLER SPECIAL SQUARE STAINLESS STEEL STRUCTURAL STEEL TUBING STORM, STORAGE		
R /C	BACK WATER CHECK VALVE CONDUIT COMPRESSED AIR	TH I	FIRE EXTINGUISHER FIRE EXTINGUISHER CABINET FINISHED FLOOR, FACTORY FINISH FINISHED FLOOR ELEVATION FINISHED FLOOR LINE FIRE HYDRANT FIRE HOSE CABINET	MULL N N/A NAT NC	MULLION NORTH NOT APPLICABLE NATURAL NORMALLY CLOSED	STA STC STD STG STL STN	STATION SHOWER TEMP CONTROLLER STANDARD SEATING STEEL STAIN (ED)		
D M R	CATCH BASIN CHALKBOARD CEILING DIFFUSER CEMENT CERANIC	FHC FIN FIXT FL FLD FLEX	FIRE HOSE CABINET FINISH (ED) FIXTURE FLUSH FLOOR DUCT FLEXIBLE FLASHING	NEC NEG NEUT NIC NO NOM	NATIONAL ELECTRIC CODE NEGATIVE NEUTRALIZATION NOT IN CONTRACT NUMBER, NORMALLY OPEN NORMAL NOISE REDUCTION COEFFICIENT	STOR STR SURF SUSP SVCI SW	STORAĞE' STRUCTURAL SURFACE SUSPENDED SERVICE WEIGHT CAST IRON SWITCH, SOFTENED WATER SYMMETRICAL		
MF UV	COLD FORMED METAL FRAMING CEILING GRILL CABINET HEATER CEILING HUNG UNIT VENTILATOR	L KIII)	FLOOR (ING) FLUORESCENT FLOOR MOUNTED	NRC NTS OA OC OD	NOT TO SCALE OVERALL, OUTSIDE AIR ON CENTER OUTSIDE DIAMETER	SYM SYS T T&B T&D T&G	SYMMETRICAL SYSTEM TREAD, TOP TOP AND BOTTOM TACK BOARD TOUGH AND GROOVE		
€C G KG	CIRCUMFERENCE CONTROL JOINT CENTER LINE CEILING CAULKING	FOS FOV FP FPM FR FRA	FUEL OIL GAUGE FUEL OIL RETURN FUEL OIL SUPPLY FUEL OIL VENT FIREPROOF (ING) FEET PER MINUTE FRAME FRESH AIR	OH OPNG OPP OPPHD PAR	Overhead OPENING OPPOSITE OPPOSITE HAND PARALLEL	TC TDV TEL TEMP TERR	TEMPERATURE CONTROL TRIPLE DUTY VALVE TELEPHONE TEMPERATURE TERRAZZO		
R RM T IU DP	CLEAR (ING) CLASSROOM CERAMIC MOSAIC TILE CONCRETE MASONRY UNIT CLEAN OUT, CARBON MONOXIDE, COMPANY CLEAN OUT DECK PLATE	FRC FRP FRT FSD FT FTG	FIRE RESISTANT COATING FIBERGLASS REINFORCED PANEL FIRE RETARDANT FIRE AND SMOKE DAMPER FOOT FOOTING	PART PC PCB PCC PE PED	PARTITION PLUMBING CONTRACTOR PORCELAIN FLOOR TILE PRECAST CONCRETE PORCELAIN ENAMEL PEDESTAI	TG THK THR TME TMV TOC	TOP GRILLE THICKNESS THRESHOLD TO MATCH EXISTING THERMOSTATIC MIXING VALVE TOP OF CASCALA		
MB MP NC ND	COLUMIN COMBINATION COMPRESS (ED) (ION) (IBLE) CONCRETE CONDENSATE (HTG & VENTILATION)	G GA GAL GALV	FLUSH VALVE GAS GAGE, GAUGE	PERF PFT PERI PL PLAM PLAS PLF	PERFORATE (ION) (ED) PORCELAIN FLOOR TILE PERIMETER PLATE, PROPERTY LINE PLASTIC LAMINATE PLASTER, PLASTIC POUNDS PER LINEAR FOOT	TOF TOIL TOL TOM TOP TOS TPART	TOP OF FASCIA TOILET TOLERANCE TOP OF MASONRY TOP OF PIPE, TOP OF PIER TOP OF STEEL TOILET PARTITION		
NI NTR RR WP T	CLEAN OUT WALL PLATE	GASK GC GCO GCMU GD GF	GALVANIZED, GALVANIC GASKET (ED) GENERAL CONTRACT (OR) GRADE CLEANOUT GLAZED CONCRETE MASONRY UNIT GROUND GROUND FACE	PM PLYWD PNL POC POL	PLUGMOLD PLYWOOD PANEL POINT OF CURVATURE POLISHED	TR TR TRN TV TOW TW	TOILET PARTITION TOP REGISTER TRANSOM TELEVISION TOP OF WALL TEMPERED WATER TYPICAL		
Š MT	CERAMIC TILE, COMPUTER TERMINAL	GL GPM GR GS GVL GWB	GLASS GALLONS PER MINUTE GRADE (ING), GLYCOL RETURN GLYCOL SUPPLY GRAVEL GYPSUM WALL BOARD	POS POT PR PRE PREP PRF	POSITIVE POINT OF TANGENCY PAIR POWER ROOF EXHAUSTER PREPARE (ATION) PREFORMED PROJECT (TION)	UC UD UE UGND	UNDERCUT UNDER DRAIN UNDERGROUND ELECTRIC UNDERGROUND		
) { FT ,	COUNTER TOP COATED CENTER CUBIC FEET CONVECTOR, CURB VALVE COLD WATER	H HB HBD HC	GYPSUM HEIGHT HOSE BIB HARD BOARD HEATING CONTRACTOR HOT/CHILLED RETURN HOT/CHILLED SUPPLY	PROJ PSF PSI PT PTD PTP	PROJECT (TION) POUNDS PER SQUARE FOOT POUNDS PER SQUARE INCH POINT PAINTED PRESSURE TREATED PRESERVATIVE PRESSURE TREATED FIRE PETARDANT	UH UNF UNO UR UT UV	UNIT HEATER UNFINISHED UNLESS OTHERWISE NOTED URINAL UNDERGROUND TELEPHONE UNIT VENTILATOR, ULTRAVIOLET		
/S	CHILLED WATER SUPPLY DIESEL FUEL, DEPTH DIRECT CURRENT DIRECT DIGITAL CONTROL	HCR HCS HD HDR HDW HM	HEAVY DUTY HEADER HARDWARE HOLLOW METAL	PTFR PVC PVMT PWE	PRESSURE TREATED FIRE RETARDANT POLYVINYL CHLORIDE PAVEMENT POWER WALL EXHAUSTER QUARRY TILE	V VAR VARN VAT VB	VENT, VOLT VARIES, VARIABLE VARNISH VINYL ASBESTOS TILE VINYL BASE, VACUUM BREAKER,		
G MO P	DEIONIZED WATER DEGREES DEMOLISH DEPRESS (ED) (ION)	HORZ HP HPL HR	HORIZONTAL HORSEPOWER, HIGH PRESSURE HIGH PRESSURE LAMINATE HANDRAIL, HOUR	R R&R RA	RISER, RADIUS REMOVE EXISTING & REPLACE W/NEW RETURN AIR	VCT VD VERM	VAPOR BARRIER VINYL COMPOSITE TILE VOLUME DAMPER VERMICULITE		

GENERAL NOTES


- DESIGN AND CONSTRUCTION SHALL CONFORM TO ALL LOCAL AND STATE CODES, INCLUDING (BUT NOT LIMITED TO) THE "NEW YORK STATE UNIFORM FIRE PROTECTION AND BUILDING CODE", LATEST REVISION, THE NFPA 101 LIFE SAFETY CODE, LATEST REVISION, ANSI A117.1 -1992 (REVISED 1995), S.E.D. MANUAL OF PLANNING STANDARDS, LATEST REVISION, OSHA, AND ANY OTHER CODES GOVERNED BY THE JURISDICTION IN WHICH THIS PROJECT IS BEING CONSTRUCTED.
- INTERIOR AND EXTERIOR CONCRETE SLABS SHALL BE SEPARATED FROM ANY VERTICAL SURFACE WITH AN ISOLATION JOINT. ALL SLAB-ON-GRADE (CONTROL, EXPANSION, ETC.) JOINTS TO RECEIVE SEALANT FOR RADON PROTECTION.
- THIS CONTRACT REQUIRES COMPLETE, FINISHED WORKABLE PROJECT OF THE AREAS INDICATED BY THE CONTRACT DOCUMENTS, AND SHALL INCLUDE ALL MATERIALS AND LABOR NECESSARY TO COMPLETE SAME, REGARDLESS OF WHETHER OR NOT EACH AND EVERY NECESSARY WORK OR ITEM IS SPECIFICALLY INDICATED ON ANY OTHER PORTION OF THE DRAWINGS AND/OR NOTES.
- WHERE MATERIALS REFERENCED ON DRAWINGS, OR NECESSARY TO COMPLETE THE WORK OF THIS CONTRACT ARE NOT SPECIFIED HEREIN, PROVIDE BEST QUALITY MATERIALS. WHERE MATERIALS ARE INTENDED TO MATCH EXISTING, PROVIDE CLOSEST POSSIBLE MATCH, SUBJECT TO OWNER'S APPROVAL. ALL ITEMS AND WORK ON DRAWINGS ARE NEW, UNLESS INDICATED EXISTING. ALL WORK WHICH HAS BEEN DAMAGED SHALL BE REPAIRED OR REPLACED. WHERE ITEM CAN NOT BE REPAIRED TO A "NEW CONDITION", OR WHERE THE STRUCTURAL INTEGRITY HAS BEEN AFFECTED, ITEM SHALL BE REPLACED, AT NO COST TO THE OWNER.
- ALL CONTRACTORS ARE RESPONSIBLE TO VERIFY ALL SITE, FIELD AND BUILDING CONDITIONS PRIOR TO SUBMITTING BIDS AND COMMENCING WORK, IF THERE ARE ANY DISCREPANCIES BETWEEN DRAWINGS AND FIELD CONDITIONS, CONFER WITH ARCHITECT / ENGINEER FOR RESOLUTION.
- DRAWINGS DO NOT INDICATE ALL DEMOLITION / REMOVALS. ALL CONTRACTORS ARE TO REFER TO DRAWINGS, SPECIFICATIONS AND VERIFY FIELD CONDITIONS TO DETERMINE FULL SCOPE AND PARTICULARS OF REMOVAL REQUIREMENTS PRIOR TO BIDDING WORK. CONFER WITH OWNER WHICH ITEMS ARE TO BE SAVED FOR OWNER'S USE OR REINSTALLATION BY CONTRACTOR.
- CONTRACTOR SHALL OBTAIN FROM OWNER ALL REQUIREMENTS FOR INSTALLATION OF OWNER PROVIDED EQUIPMENT INCLUDING ROUGHING DIAGRAMS, INSTALLATION INSTRUCTIONS, ELECTRICAL SCHEMATICS, TEMPLATES, LAYOUTS AND DIMENSIONS AND ALL OTHER INFORMATION NECESSARY FOR A PROPER, WELL COORDINATED INSTALLATION. PRIOR TO ROUGH-IN OF SERVICES, CONFER WITH OWNER EXACT LOCATION OF ALL ITEMS.
- ALL PENETRATIONS THROUGH FLOORS AND FULL HEIGHT WALLS TO BE FIRE STOPPED. ALL GAPS AND JOINTS AT RATED FLOORS, ROOFS AND WALLS TO BE FIRE STOPPED. GAPS AND JOINTS INCLUDE (BUT ARE NOT LIMITED TO) TOP OF WALL TO FLOOR OR ROOF DECK, WALL TO BEAMS, AND CONTROL OR EXPANSION JOINTS. FIRE STOPPING INCLUDES BOTH FORM OR PACKING MATERIAL AND THE FILL, VOID OR CAVITY MATERIAL.
- EXTERIOR PERIMETER OF ALL WINDOWS, DOOR FRAMES, LOUVERS, OR OTHER ITEMS INSERTED IN AN EXTERIOR WALL SHALL BE SEAL WEATHER TIGHT WHETHER INDICATED ON DRAWINGS OR NOT.
- WOOD USED FOR BLOCKING OR OTHER PURPOSES ON OR ABOVE THE ROOF DECK, WITHIN 2'-0" OF GRADE AND OTHER LOCATIONS OUTSIDE THE BUILDING ENVELOPE WHERE EXPOSED TO THE WEATHER, SHALL BE PRESSURE TREATED TYPE (P.T.P). ALL INTERIOR WOOD FOR BLOCKING OR OTHER PURPOSES TO BE FIRE RETARDANT (PTFR)
- FINISHED DOOR OPENINGS SHALL BE NOMINAL @ 6" FROM FINISHED CORNER OF ROOM AT HINGE SIDE, EXCEPT WHERE DIMENSIONED OTHERWISE. ON THE 'PULL' SIDE OF A DOOR OPENING, THE STRIKE SIDE SHALL BE NOMINAL 18" FRAME PERPENDICULAR WALL. ON THE "PUSH" SIDE OF A DOOR OPENING EQUIPPED W/ BOTH A CLOSER AND LATCH, THE STRIKE SIDE SHALL BE NOMINAL 12" FROM A PERPENDICULAR WALL.
- 12. PROVIDE BUILDING EXPANSION JOINT AND CONTROL JOINTS AT INTERIOR AND EXTERIOR MASONRY WALLS PER THE BRICK INSTITUTE OF AMERICA AND THE NATIONAL CONCRETE MASONRY ASSOCIATION SPECIFICATIONS AND RECOMMENDATIONS AND WHERE BUILDING ADDITIONS MEET EXISTING BUILDING. AT RATED WALLS, EXPANSION JOINT OR CONTROL JOINT TO EQUAL WALL RATING.
- REMOVE DEBRIS AND OTHER MATERIALS (RESULTING FROM DEMOLITION) FROM SITE AS DEMOLITION PROGRESSES. REMOVE RUBBISH FROM JOB SITE REGULARLY AND LEAVE PREMISES AND WORK IN CLEAN CONDITION. RUBBISH SHALL NOT BE ALLOWED TO ACCUMULATE AND SHALL BE APPROPRIATELY DISPOSED OF. PRIOR TO COMPLETION, CLEAN PREMISES FOR OCCUPANCY BY OWNER.
- . ALL CONTRACTORS ARE TO COORDINATE THE WORK OF EACH OTHER SO THAT THE WORK AND SCHEDULE ARE NOT IMPEDED. SCHEDULE WORK PROGRESS THROUGHOUT THE ENTIRE PROJECT TO PREVENT CONFLICTS AND INTERFERENCES. OBTAIN ALL NECESSARY INFORMATION SUCH AS SIZES, LOCATIONS, TEMPLATES, LAYOUT, DIMENSIONS AND ALL OTHER INFORMATION NECESSARY FOR A PROPER AND WELL COORDINATED INSTALLATION. PRIOR TO INSTALLATION OF ITEMS, CONFER WITH EACH CONTRACTOR EXACT LOCATION OF ALL ITEMS.
- . | ALL VERTICAL CONCRETE SURFACES WHICH WILL BE EXPOSED TO VIEW UPON COMPLETION OF WORK SHALL RECEIVE A SMOOTH
- . ALL ENDS OF MASONRY WALLS THAT WILL BE EXPOSED TO VIEW UPON COMPLETION OF WORK SHALL BE BULLNOSE ENDS UNITS.
- ALL CMU SHALL HAVE HORIZONTAL JOINT REINFORCING AT EVERY OTHER COURSE, UNLESS OTHERWISE NOTED.
- 18. METAL STUDS SHALL BE 22 GA. AT 16" O.C. UNLESS NOTED
- OTHERWISE.
- DEACH CONTRACTOR SHALL BE RESPONSIBLE FOR MAKING OPENINGS IN WALLS AND FLOOR SYSTEMS FOR INSTALLATION OF THEIR WORK. MECHANICAL. PLUMBING AND ELECTRICAL CONTRACTORS SHALL PROVIDE LOCATIONS OF ROOF OPENINGS TO GENERAL CONSTRUCTION CONTRACTOR
- 20. ELECTRICAL, MECHANICAL OR PLUMBING PENETRATIONS THROUGH FIRE-RATED WALL OR FLOOR ASSEMBLIES (IF ANY - SEE CODE REVIEW) SHALL BE SEALED BY EACH RESPONSIBLE CONTRACTOR WITH A U.L. APPROVED THROUGH-PENETRATION FIRESTOP SYSTEM APPROPRIATE FOR THE RATING OF THE WALL BEING PENETRATED. SUBMIT PROPOSED U.L. NUMBERS AND DETAILS TO ARCHITECT FOR REVIEW AND APPROVAL PRIOR TO INSTALLATION.
- ANY COLORS/FINISHES NOT SPECIFICALLY IDENTIFIED SHALL BE SELECTED FROM MANUFACTURER'S STANDARD COLOR/FINISHES DURING SUBMITTAL REVIEW.
- ALL STEEL MEMBERS (INCLUDING BUT NOT LIMITED TO: COLUMNS BASE PLATES, BEAMS, JOISTS, FLOOR/ROOF DECK, LINTELS, BUMPER RAILS, HANDRAILS, GUARDRAILS, MISCELLANEOUS PLATES, STAIRS/RISERS/LANDINGS, CONDUIT, DUCTWORK, PIPING HANGERS ETC.) THAT ARE EXPOSED TO VIEW UPON COMPLETION OF THE PROJECT SHALL BE FIELD PAINTED, UNLESS SPECIFICALLY NOTED
- CONTRACTOR TO FURNISH AND INSTALL FIRE EXTINGUISHER CABINETS.



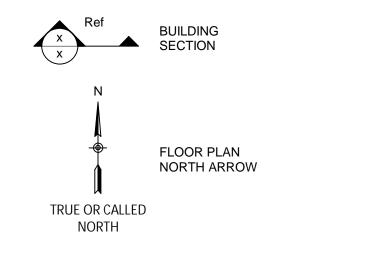

ROOM NAME 101

IDENTIFICATION

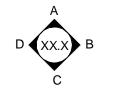

ELEVATION MARKER



ELEVATION MARKER

IDENTIFICATION

101

WINDOW IDENTIFICATION

IDENTIFICATION


KEY NOTE TAG

FIRE EXTINGUISHER (WALL BRACKET MOUNTED)

ELEVATION

MARKER **NEW COLUMN GRID MARKER**

REVISION

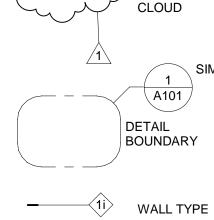

ROOM NAME <u>Room name</u> WITH ROOM SQUARE FEET

STANDARD MATERIAL HATCH

PLYWOOD EARTH PLASTER, MORTAR, GRAVEL SAND, GYPSUM CONCRETE RIGID INSULATION C.M.U OTHER METAL BRICK ST. GLAZED TILE BLOCKING CERAMIC TILE FINISH WOOD BATT INSULATION PRECAST CONC. STEEL STEEL METAL STUD FRAMED WALLS

***NOTE: THE ABOVE STANDARD SYMBOLS ARE PROVIDED FOR GENERAL REFERENCE AND MAY OR MAY NOT BE REPRESENTATIVE OF ALL SYMBOLS USED THROUGHOUT THE CONTRACT DOCUMENTS.


IT IS A VIOLATION OF THE NEW YORK STATE EDUCATION LAW, ARTICLE 145 §7209 SPECIAL PROVISIONS, FOR ANY PERSON UNLESS THEY ARE ACTING UNDER THE DIRECTION OF A LICENSED PROFESSIONAL ENGINEER, ARCHITECT, LANDSCAPE ARCHITECT, OR LAND SURVEYOR, TO ALTER AN ITEM IN ANY WAY. IF AN ITEM BEARING THE STAMP OF A LICENSED PROFESSIONAL IS ALTERED. THE ALTERING PROFESSIONAL SHALL STAMP THE DOCUMENT AND INCLUDE THE NOTATION "ALTERED BY FOLLOWED BY THEIR SIGNATURE, THE DATE OF SUCH ALTERATION, AND A SPECIFIC

DESCRIPTION OF THE ALTERATION REVISIONS

EVIATION

BBRI \triangleleft ш Z S SYMBOL RD

CAYUGA LAKE INTERMUNICIPAL WATER COMM WATER TREATMENT FACILITY ELECTRICAL

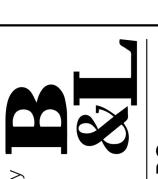

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AND,

ST

OCTOBER, 2023

AS SHOWN Sheet Number

	ALLOWABLE HEIGHT (503/504)							
	ACTUAL	ALLOWABLE (TABLE 503)	INCREASE FOR SPRINKLERS					
BUILDING HEIGHT IN FEET	20' - 6"	55' - 0"	N/A					
BUILDING HEIGHT IN STORIES	1 STORY	2 STORIES	N/A					

OCCUPANT LOAD & EXIT WIDTH (1003) (a) (b) (c) (d) EXIT WIDTH (in)											
	(a)	(b)	(c)	(d))		EXIT WI	DTH (in)			
USE GROUP OR SPACE DESCRIPTION	AREA (sq. ft.)	AREA PER OCCUPANT	OCCUPANT LOAD	EGRESS W		REQUIRED WIDTH (SECTION 1003.2.3) c x d		ACTUAL WIDTH SHOWN ON PLANS			
		(TABLE 1003.2.2.2)	(a/b)	STAIR	LEVEL	STAIR	LEVEL	STAIR	LEVEL		
F-1	660	300	3	0.3"	2	36"	.6"	48"	68"		

		ALLO\	WABLE FLOOR ARE	EA (503/506)	ALLOWABLE AREA 15,500					
STORY NO.	BUILDING AREA PER STORY (ACTUAL)	NEW AREA (ADDITION, S.F.)	OVERALL FLOOR AREA (S.F.)	AREA FOR SPINKLER INCREASE	ALLOWABLE AREA					
1	ELECTRICAL ROOM ADDITION	660	19,660	N/A	15,500					
a. PERIME b. TOTAL c. RATIO (F d. W = MIN	CE AREA INCREASES FROM SECTION ETER WHICH FRONTS A PUBLIC WAY BUILDING PERIMETER = (P) F/P) = (F/P) NIMUM WIDTH OF PUBLIC WAY = (W) NT OF FRONTAGE INCREASE I = 100(F	OR OPEN SPACE HAVING		H = (F)						

		NUM	BER AND AF	RRANGEN	MENT OF EXITS (1003/1004/1005)					
FLOOR, ROOM OR SPACE DESIGNATION	ACTUAL		TRAVEL DI	STANCE	ARRANGEMENT MEANS OF EGRESS (1004.2.2)					
SPACE DESIGNATION	REQUIRED	ACTUAL	ALLOWABLE	ACTUAL	REQUIRED DISTANCE BETWEEN EXIT DOORS	ACTUAL DISTANCE SHOWN ON PLAN				
ELECTRICAL ROOM ADDITION	1	1	75' - 0"	54' - 10"	-	-				

2020 EXISTING BUILDING CODE OF NEW YORK STATE REVIEW

CHAPTER 11 ADDITIONS

1101.1 SCOPE. AN ADDITION TO A BUILDING OR STRUCTURE SHALL COMPLY WITH THE UNIFORM CODE AS ADOPTED FOR NEW CONSTRUCTION WITHOUT REQUIRING THE EXISTING BUILDING OR STRUCTURE TO COMPLY WITH ANY REQUIREMENTS OF THOSE CODES OR OF THESE PROVISIONS, EXCEPT AS REQUIRED BY THIS CHAPTER. WHERE AN ADDITION IMPACTS THE EXISTING BUILDING OR STRUCTURE, THAT PORTION SHALL COMPLY WITH THIS CODE.

1101.2 CREATION OR EXTENSION OF NONCONFORMITY

AN ADDITION SHALL NOT CREATE OR EXTEND ANY NONCONFORMITY IN THE EXISTING BUILDING TO WHICH THE ADDITION IS BEING MADE WITH REGARD TO ACCESSIBILITY, STRUCTURAL STRENGTH, FIRE SAFETY, MEANS OF EGRESS, OR THE CAPACITY OF MECHANICAL, PLUMBING, OR ELECTRICAL SYSTEMS.

1102.2 AREA LIMITATIONS

AN ADDITION SHALL NOT INCREASE THE AREA OF AN EXISTING BUILDING BEYOND THAT PERMITTED UNDER THE APPLICABLE PROVISIONS OF CHAPTER 5 OF THE BUILDING CODE OF NEW YORK STATE FOR NEW BUILDINGS UNLESS FIRE SEPARATION AS REQUIRED BY THE BUILDING CODE OF NEW YORK STATE IS PROVIDED.

1102.3 FIRE PROTECTION SYSTEMS

EXISTING FIRE AREAS INCREASED BY THE ADDITION SHALL COMPLY WITH CHAPTER 9 OF THE BUILDING CODE OF NEW YORK STATE.

2020 BUILDING CODE OF NEW YORK STATE REVIEW

SUMMARY:

- OCCUPANCY CLASSIFICATION: GROUP F-1, ELECTRICAL ROOM
- CONSTRUCTION CLASSIFICATION: IIB
- AUTOMATIC SPRINKLER SYSTEM: NOT REQUIRED.

CHAPTER 3 OCCUPANCY CLASSIFICATION AND USE

306.2 MODERATE-HAZARD FACTORY INDUSTRIAL, (ELECTRICAL ROOM ADDITION) GROUP F-1

CHAPTER 5 GENERAL BUILDING HEIGHTS AND AREAS

TABLE 504.3 ALLOWABLE BUILDING HEIGHT IN FEET ABOVE GRADE PLANE

F-1, IIB, NOT SPRINKLERED = 55' - 0"

TABLE 506.2 ALLOWABLE AREA FACTOR F-1, IIB, NOT SPRINKLERED = 15,500 S.F.

ACTUAL = 660 S.F. ADDITION + 19,000 S.F. EXISTING WATER TREATMENT PLANT = 19,660 S.F. TOTAL (SEPARATION REQUIRED)

CHAPTER 6 TYPES OF CONSTRUCTION

TABLE 601/602 FIRE-RESISTANCE RATING REQUIREMENTS FOR BUILDING ELEMENTS (HOURS) TYPE IIB:

- PRIMARY STRUCTURAL FRAME = 0 HOURS
- BEARING WALLS, EXTERIOR = 0 HOURS (DISTANCE < 30' 0")
- ROOF AND FLOOR CONSTRUCTION = 0 HOURS

CHAPTER 7 FIRE AND SMOKE PROTECTION FEATURES

SECTION 707 FIRE BARRIERS.

FIRE BARRIERS INSTALLED AS REQUIRED ELSEWHERE IN THIS CODE OR THE FIRE CODE OF NEW YORK STATE SHALL COMPLY WITH THIS SECTION.

707.3.10 FIRE AREAS. THE FIRE BARRIERS, FIRE WALLS OR HORIZONTAL ASSEMBLIES, OR COMBINATION THEREOF, SEPARATING A SINGLE OCCUPANCY INTO DIFFERENT FIRE AREAS SHALL HAVE A FIRE-RESISTANCE RATING OF NOT LESS THAN THAT INDICATED IN TABLE 707.3.10. THE FIRE BARRIERS, FIRE WALLS OR HORIZONTAL ASSEMBLIES, OR COMBINATION THEREOF, SEPARATING FIRE AREAS OF MIXED OCCUPANCIES SHALL HAVE A FIRE-RESISTANCE RATING OF NOT LESS THAN THE HIGHEST VALUE INDICATED IN TABLE 707.3.10 FOR THE OCCUPANCIES UNDER CONSIDERATION.

TABLE 707.3.10 FIRE-RESISTANCE RATING REQUIREMENTS FOR FIRE BARRIERS, FIRE WALLS OR HORIZONTAL ASSEMBLIES BETWEEN FIRE AREAS: F-1 = 3 (HOURS)

707.5 CONTINUITY

FIRE BARRIERS SHALL EXTEND FROM THE TOP OF THE FOUNDATION OR FLOOR/CEILING ASSEMBLY BELOW TO THE UNDERSIDE OF THE FLOOR OR ROOF SHEATHING, SLAB OR DECK ABOVE AND SHALL BE SECURELY ATTACHED THERETO. SUCH FIRE BARRIERS SHALL BE CONTINUOUS THROUGH CONCEALED SPACE, SUCH AS THE SPACE ABOVE A SUSPENDED CEILING. JOINTS AND VOIDS AT INTERSECTIONS SHALL COMPLY WITH SECTIONS 707.8 AND 707.9

707.6 OPENINGS

OPENINGS IN A FIRE BARRIER SHALL BE PROTECTED IN ACCORDANCE WITH SECTION 716. OPENINGS SHALL BE LIMITED TO A MAXIMUM AGGREGATE WIDTH OF 25 PERCENT OF THE LENGTH OF THE WALL, AND THE MAXIMUM AREA OF ANY SINGLE OPENING SHALL NOT EXCEED 156 SQUARE FEET.

707.8 JOINTS

JOINTS MADE IN OR BETWEEN FIRE BARRIERS, AND JOINTS MADE AT THE INTERSECTION OF FIRE BARRIERS WITH UNDERSIDE OF A FIRE-RESISTANCE-RATED FLOOR OR ROOF SHEATHING, SLAB OR DECK ABOVE, AND THE EXTERIOR VERTICAL WALL INTERSECTION SHALL COMPLY WITH SECTION 715.

715.1 GENERAL

JOINTS INSTALLED IN OR BETWEEN FIRE-RESISTANCE-RATED WALLS, FLOOR OR FLOOR/CEILING ASSEMBLIES AND ROOFS OR ROOF/CEILING ASSEMBLIES SHALL BE PROTECTED BY AN APPROVED FIRE-RESISTANT JOINT SYSTEM DESIGNED TO RESIST THE PASSAGE OF FIRE FOR A TIME PERIOD NOT LESS THAN THE REQUIRED FIRE-RESISTANCE RATING OF THE WALL, FLOOR OR ROOF IN OR BETWEEN WHICH THE SYSTEM IS INSTALLED. FIRE-RESISTANT JOINT SYSTEMS SHALL BE TESTED IN ACCORDANCE WITH SECTION 715.3.

716 OPENING PROTECTIVES. OPENING PROTECTIVES REQUIRED BY OTHER SECTIONS OF THIS CODE SHALL COMPLY WITH THE PROVISIONS OF THIS SECTION AND SHALL BE INSTALLED IN ACCORDANCE WITH NFPA 80. REQUIRED FIRE WALL AND FIRE BARRIER ASSEMBLY = 3 HOURS, MINIMUM FIRE DOOR RATING = 3 HOURS

SECTION 722 CALCULATED FIRE RESISTANCE. 722.3.2 MINIMUM EQUIVALENT THICKNESS (INCHES) OF BEARING OR NONBEARING CONCRETE MASONRY WALLS. TYPE OF AGGREGATE FOR 3-HOUR FIRE RATING: PUMICE OR EXPANDED SLAG = 4.0 INCHES EXPANDED SHALE, CLAY OR SLATE = 4.4 INCHES LIMESTONE, CINDERS OR UNEXPANDED SLAG = 5.0 INCHES CALCAREOUS OR SILICEOUS GRAVEL = 5.3 INCHES

CHAPTER 9 FIRE PROTECTION AND LIFE SAFETY SYSTEMS

903.2.4 GROUP F-1. AN AUTOMATIC SPRINKLER SYSTEM SHALL BE PROVIDED THROUGHOUT ALL BUILDINGS CONTAINING A GROUP F-1 OCCUPANCY WHERE ONE OF THE FOLLOWING CONDITIONS EXISTS: A GROUP F-1 FIRE AREA EXCEEDS 12,000 SQUARE FEET.

A GROUP F-1 FIRE AREA IS LOCATED MORE THAN THREE STORIES ABOVE GRADE PLANE. THE COMBINED AREA OF ALL GROUP F-1 FIRE AREAS ON ALL FLOORS, INCLUDING ANY MEZZANINES, EXCEEDS 24,000 SQUARE

A GROUP F-1 OCCUPANCY USED FOR THE MANUFACTURE OF UPHOLSTERED FURNITURE OR MATTRESSES EXCEEDS 2,500 SQUARE FEET.

AUTOMATIC SPRINKLER SYSTEM NOT REQUIRED (SEPARATE FIRE AREAS)

906 PORTABLE FIRE EXTINGUISHERS. 906.1 WHERE REQUIRED. GROUP F OCCUPANCIES, REQUIRED.

906.3 SIZE AND DISTRIBUTION. ORDINARY (MODERATE) HAZARD OCCUPANCY. MINIMUM RATED SINGLE EXTINGUISHER 2-A MAXIMUM FLOOR AREA PER UNIT OF A = 1,500 SQUARE FEET MAXIMUM FLOOR AREA FOR EXTINGUISHER = 11,250 SQUARE FEET MAXIMUM DISTANCE OF TRAVEL TO EXTINGUISHER = 75 FEET

CHAPTER 10 MEANS OF EGRESS

1004 OCCUPANT LOAD. TABLE 1004.5 MAXIMUM FLOOR AREA ALLOWANCES PER OCCUPANT

(300 GROSS) = 3 OCCUPANTS

1006.2.1 SPACES WITH ONE EXIT OR EXIT ACCESS DOORWAY, MAXIMUM COMMON PATH OF EXIT TRAVEL DISTANCE: F = 75' (WITHOUT SPRINKLER SYSTEM)

STAIRWAYS. 1011.2 WIDTH AND CAPACITY. THE REQUIRED CAPACITY OF STAIRWAYS SHALL BE DETERMINED AS SPECIFIED IN SECTION 1005.1, BUT THE MINIMUM WIDTH SHALL BE NOT LESS THAN 44 INCHES. EXCEPTION: STAIRWAYS SERVING AN OCCUPANT LOAD OF LESS THAN 50 SHALL HAVE A WIDTH OF NOT LESS THAN 36 INCHES


CHAPTER 11 ACCESSIBILITY - (NOT REQUIRED, EQUIPMENT SPACES)

EXCEPTIONS: 1103.2.9 EQUIPMENT SPACES. SPACES FREQUENTED ONLY BY SERVICE PERSONNEL FOR MAINTENANCE, REPAIR OR OCCASIONAL MONITORING OF EQUIPMENT ARE NOT REQUIRED TO COMPLY WITH THIS CHAPTER.


2020 ENERGY CONSERVATION CONSTRUCTION CODE OF NYS REVIEW

CLIMATE ZONE: 6A (TOMPKINS COUNTY) TABLE C402.1.3 OPAQUE THERMAL ENVELOPE INSULATION REQUIREMENTS ROOF, INSULATION ENTIRELY ABOVE ROOF DECK = R-30ci WALLS, ABOVE GRADE, MASS = R-13.3ci BELOW GRADE = R-7.5ci FLOORS, SLAB ON GRADE = R-10 FOR 24" BELOW



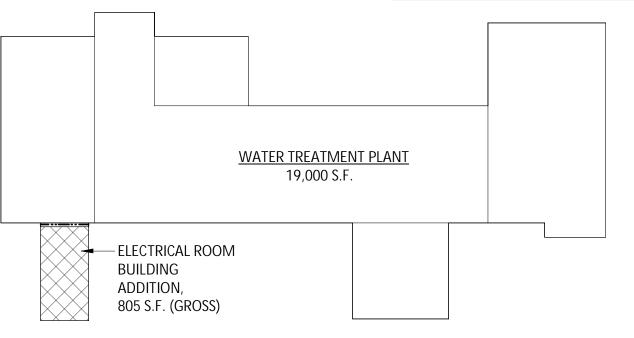



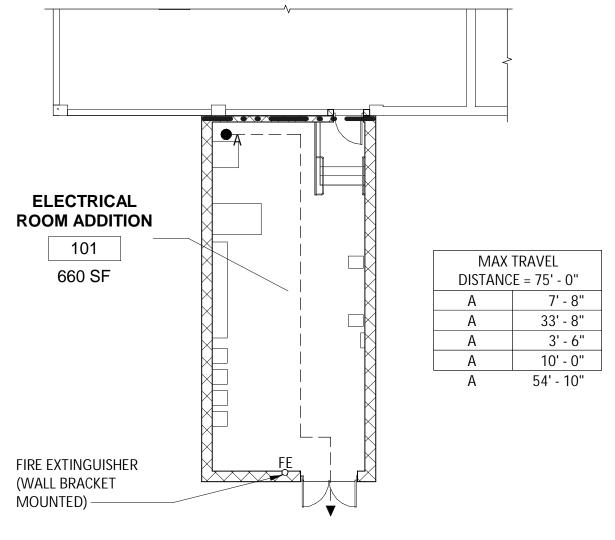

LIFE SAFETY EXIT PLAN


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DESCRIPTION OF THE ALTERATION REVISIONS

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CAYUGA WATER 0



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Sheet Number A002

Project Number 677.006.001

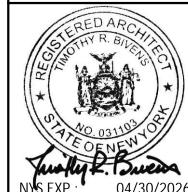
THE SPRINKLER INCREASE PER SECTION 506.3 IS AS FOLLOWS:

a. MULTI-STORY BUILDING I = 200 PERCENT

b. SINGLE STORY BUILDING I = 300 PERCENT

EXISTING/DEMOLITION FLOOR PLAN

SCALE: 1/4" = 1'-0"

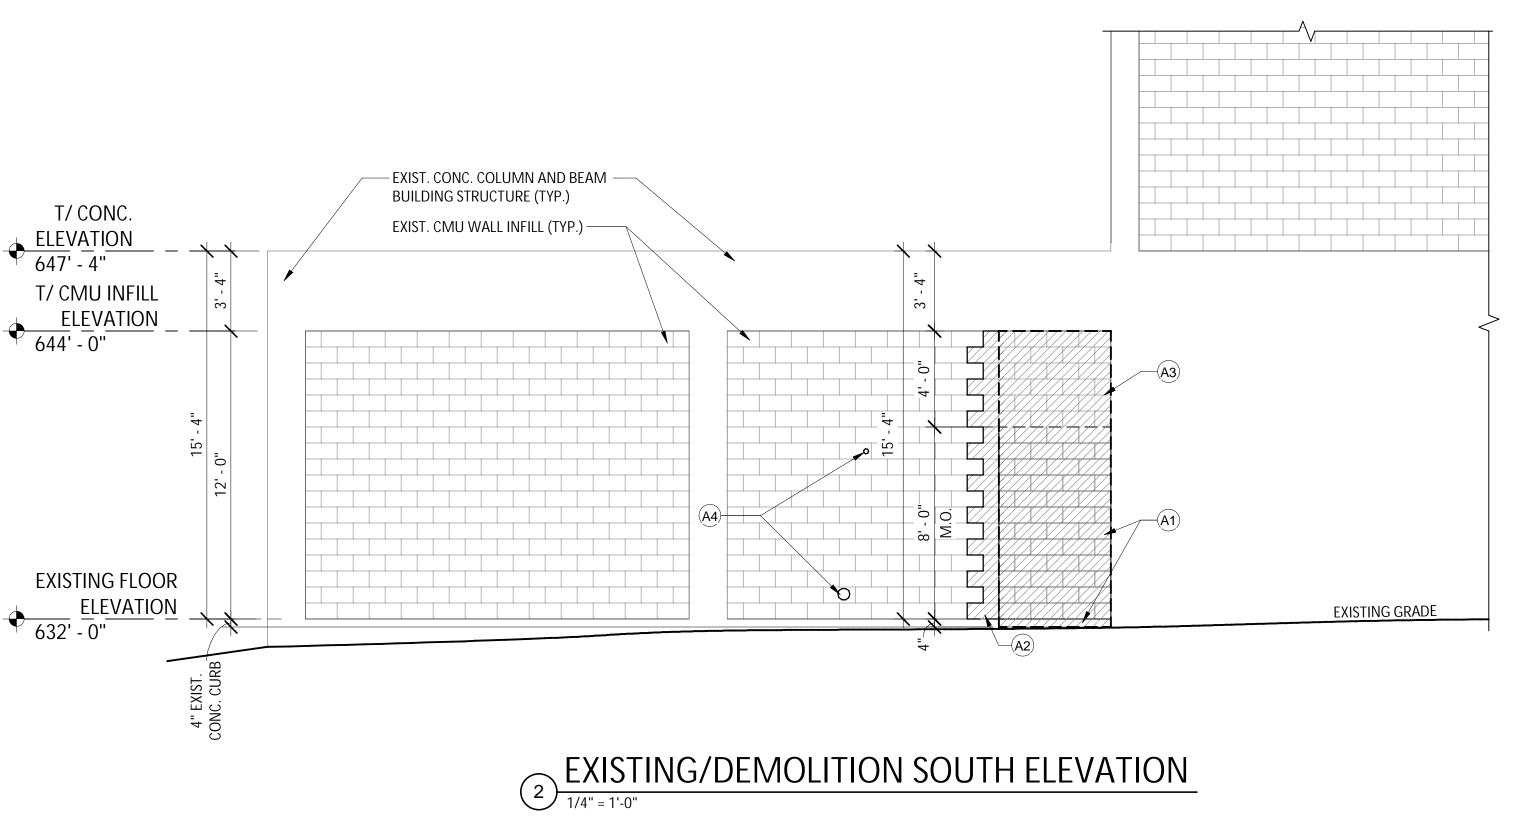

DEMO KEY NOTES

- SAWCUT & REMOVE SECTION OF CONCRETE MASONRY WALL AS SHOWN AND 4" HIGH CONCRETE CURB ABOVE EXISTING FLOOR ELEVATION, G.C. RESPONSIBLE FOR STABILIZATION OF EXISTING WALL TO REMAIN, SEE S-SHEETS FOR LINTEL FRAMING (TYP.)
- REMOVE CONCRETE MASONRY UNITS AS SHOWN FOR NEW INSTALLATION OF TOOTHING IN MASONRY END BLOCKS FOR SMOOTH WALL MASONRY OPENING JAMB
- REMOVE CONCRETE MASONRY UNITS AS SHOWN TO UNDERSIDE OF EXISTING CONCRETE BEAM, TO BE INFILLED WITH NEW CMU ABOVE NEW DOOR FRAME AND LINTEL FRAMING TO MATCH EXISTING
- EXISTING PIPING TO BE DEMOLISHED BY MECHANICAL CONTACTOR (LOCATION SHOWN APPROXIMATELY), GC TO GROUT EXISTING OPENINGS SOLID

GENERAL DEMO NOTES

- CONTRACTOR TO REVIEW AND COORDINATE DEMOLITION OF ALL WORK WITH OWNER PRIOR TO COMMENCEMENT OF WORK. CONTRACTOR(S) SHALL COORDINATE WITH OWNER WHICH ITEMS SHALL BE TURNED OVER TO THE OWNER PRIOR TO THE START OF WORK. THIS SHALL BE, BUT NOT LIMITED TO ITEMS LISTED ON THE CONTRACT DRAWINGS OR IDENTIFIED BY THE OWNER.
- ALL QUESTIONS REGARDING DEMOLITION INFORMATION CONTAINED ON THIS DRAWING SHALL BE ADDRESSED TO THE ARCHITECT.
- FIELD VERIFY EXISTING CONDITIONS, AND VERIFY WITH ARCHITECT ANY DISCREPANCIES OR CHANGES TO THE CONTRACT DOCUMENTS PRIOR TO COMMENCING DEMOLITION WORK.
- PROTECT EXISTING BUILDING FINISHES THAT ARE TO REMAIN DURING CONSTRUCTION.
- CONTRACTOR SHALL ACQUAINT THEMSELF WITH THE INTENT OF THE NEW CONSTRUCTION, AND PERFORM DEMOLITION THAT IS COMPATIBLE WITH THE PROPOSED SCOPE OF THE PROJECT AS A WHOLE.
- PATCHING: WHERE REMOVALS LEAVE HOLES AND DAMAGED SURFACES EXPOSED IN THE FINISHED WORK, PATCH AND REPAIR THESE HOLES AND DAMAGED SURFACES TO MATCH ADJACENT FINISHED SURFACES. WHERE NEW WORK IS TO BE APPLIED TO EXISTING SURFACES, PERFORM REMOVALS AND PATCHING IN A MANNER TO PRODUCE SURFACES SUITABLE FOR RECEIVING NEW WORK.
- DUST AND DEBRIS CONTROL: PROVIDE TEMPORARY INTERIOR ENCLOSURES, AS REQUIRED, TO PROTECT ALL OCCUPANTS AND TO PREVENT THE SPREAD OF DUST AND DEBRIS TO OCCUPIED PORTIONS OF THE BUILDING AND AVOID THE CREATION OF A NUISANCE OR HAZARD IN THE SURROUNDING AREA. CLEAN AND SWEEP THE WORK AREA DAILY.
- ALL MATERIALS AND EQUIPMENT REMOVED, AND NOT REUSED, SHALL BECOME THE PROPERTY OF THE CONTRACTOR AND SHALL BE REMOVED FROM THE OWNER'S PROPERTY.
- PROTECT ANY EXISTING UTILITIES, EQUIPMENT, WALLS, FLOOR FINISHES AND CEILINGS TO REMAIN FROM DAMAGE DUE TO DEMOLITION WORK. REPAIR ANY DAMAGE INCURRED WITH NEW OR LIKE MATERIALS BACK TO ORIGINAL CONDITION.
- THE CONTRACTOR IS RESPONSIBLE FOR ALL MEANS AND METHODS OF CONSTRUCTION OF EXISTING AND NEW CONSTRUCTION TO PROVIDE A COMPLETED PROJECT IN ACCORDANCE WITH ALL APPLICABLE OSHA, FEDERAL, STATE AND LOCAL RULES AND REGULATIONS.
- 11. THE CONTRACTOR IS RESPONSIBLE FOR SECURING THE ENTIRE STRUCTURE FROM WEATHER RELATED DAMAGE DURING CONSTRUCTION.
- 12. ALL REMOVAL WORK SHOWN AND REQUIRED SHALL BE BY THIS CONTRACT.
- 13. MAINTAIN ALL LEGAL EXITWAYS.

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REVISIONS

DESCRIPTION OF THE ALTERATION

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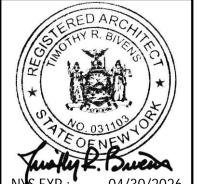
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FLOOR NOTES 3/DEMOLITION I AND I


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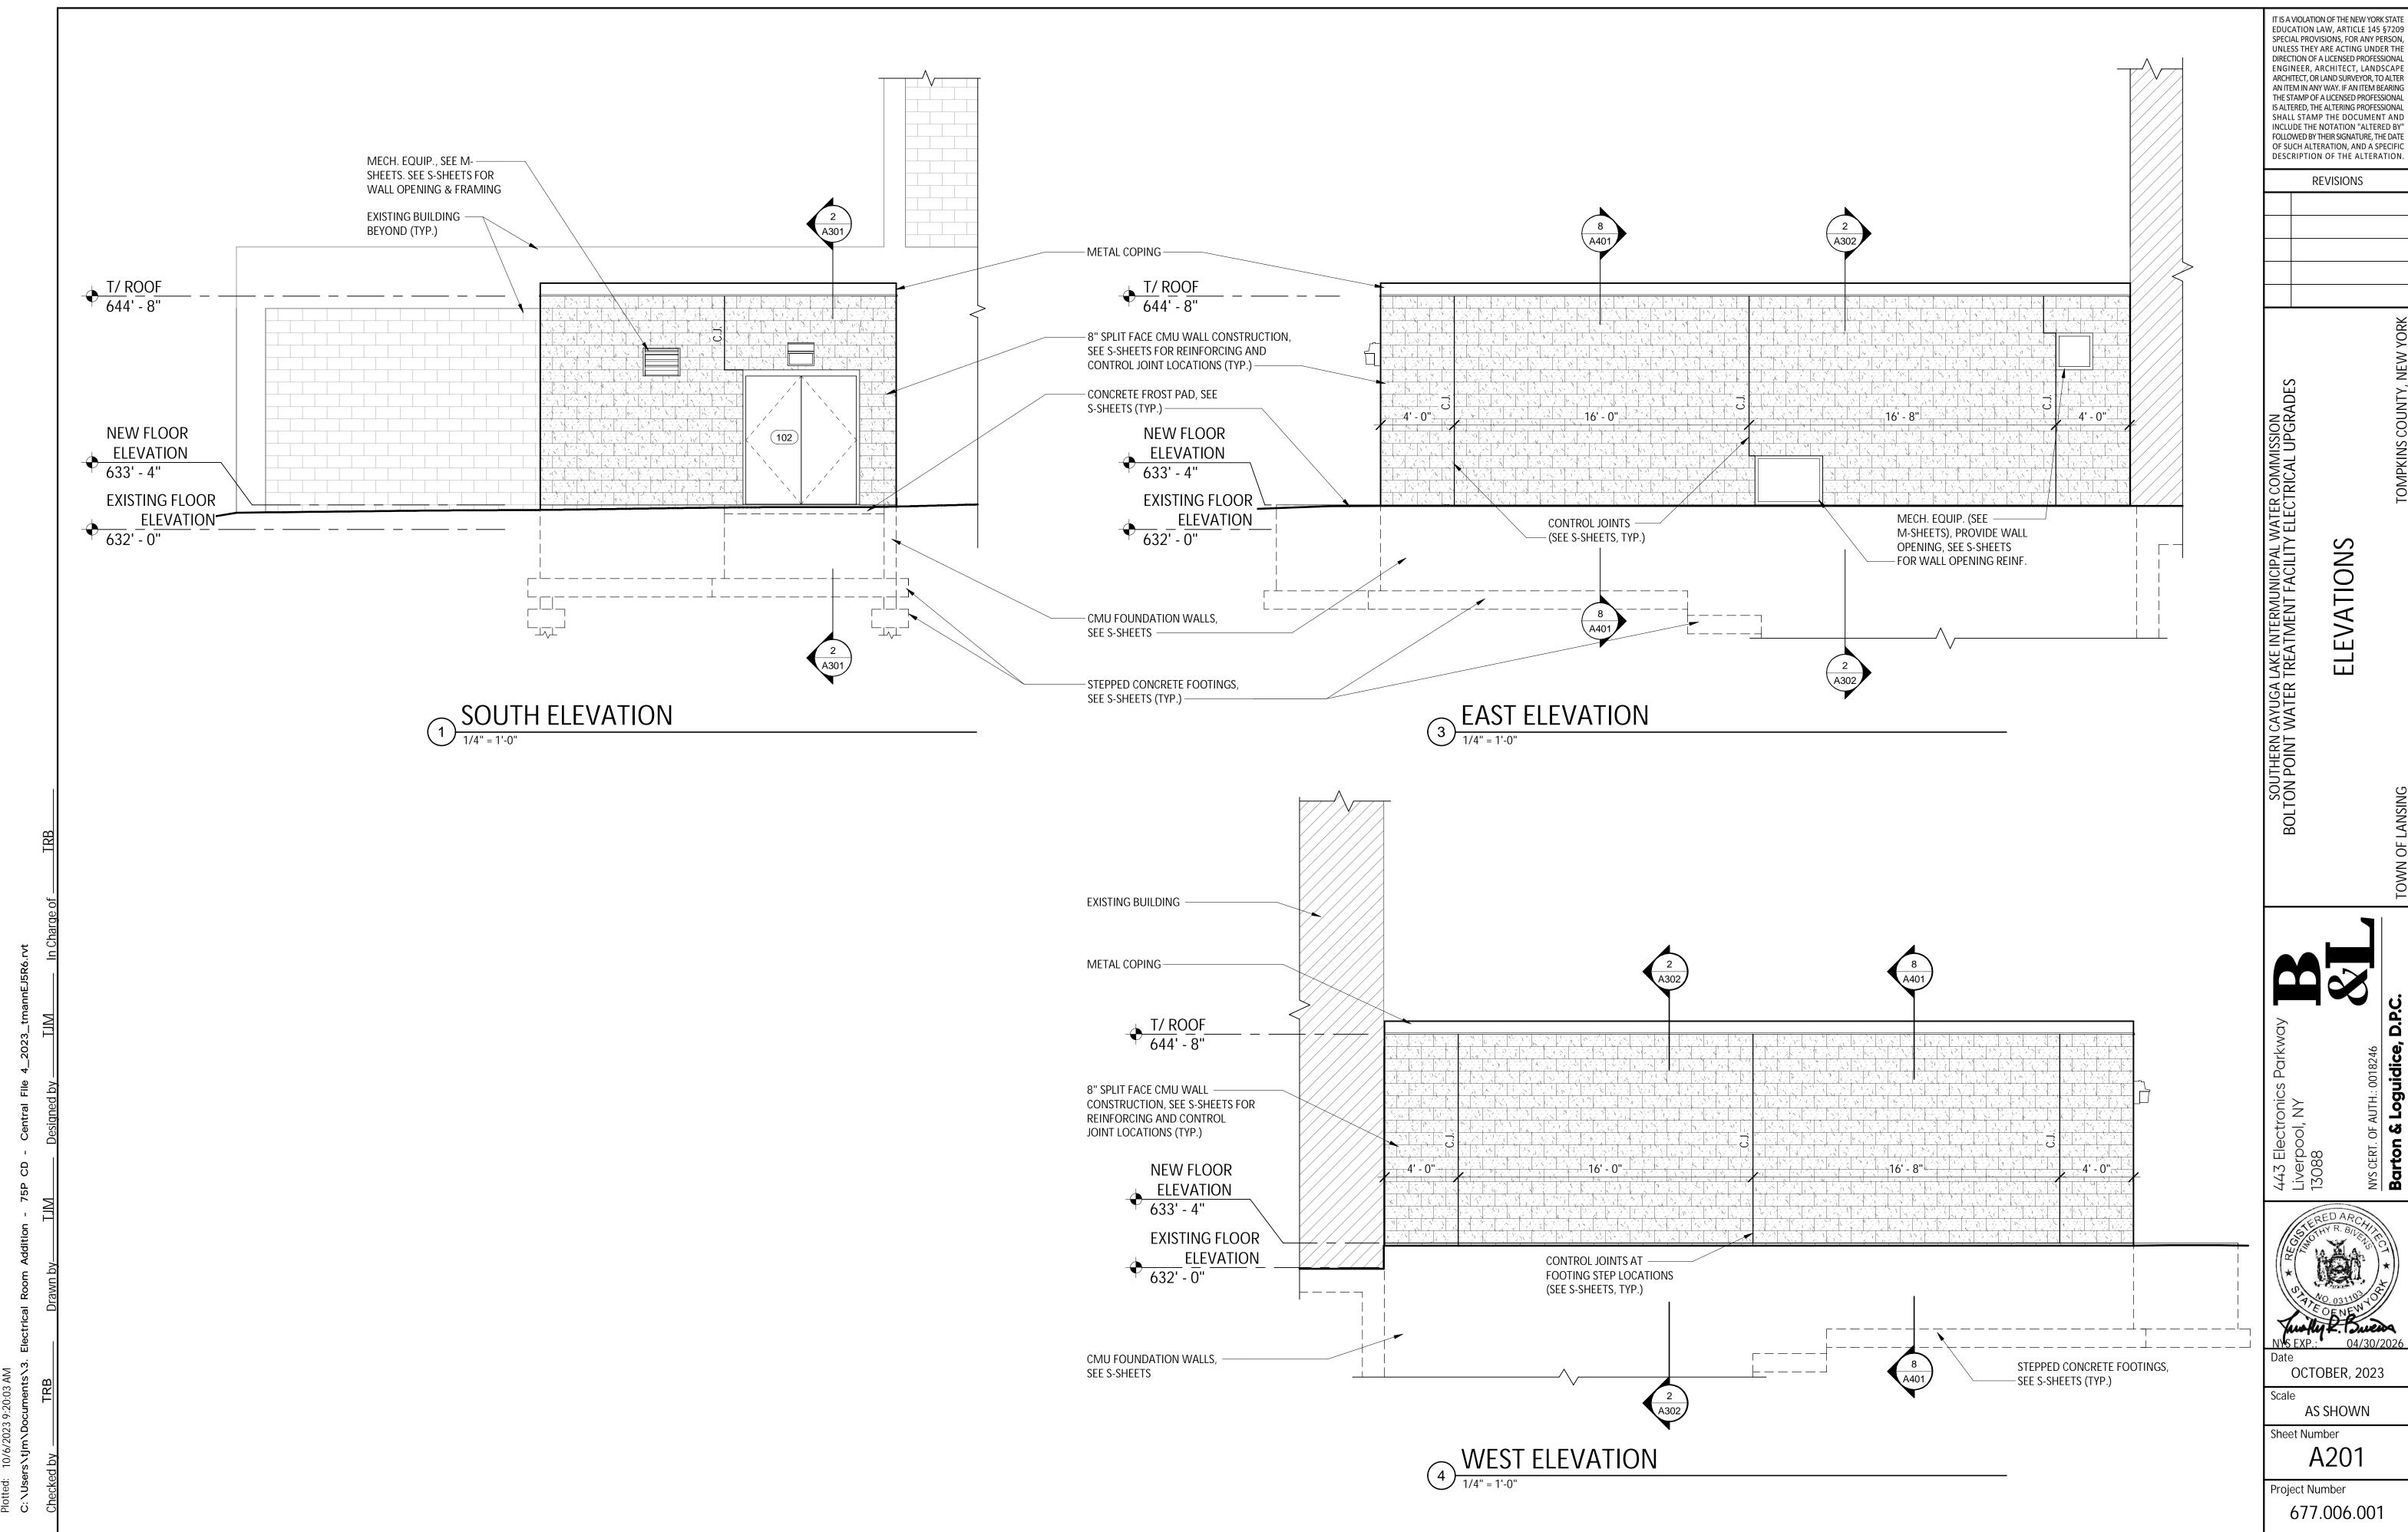



OCTOBER, 2023


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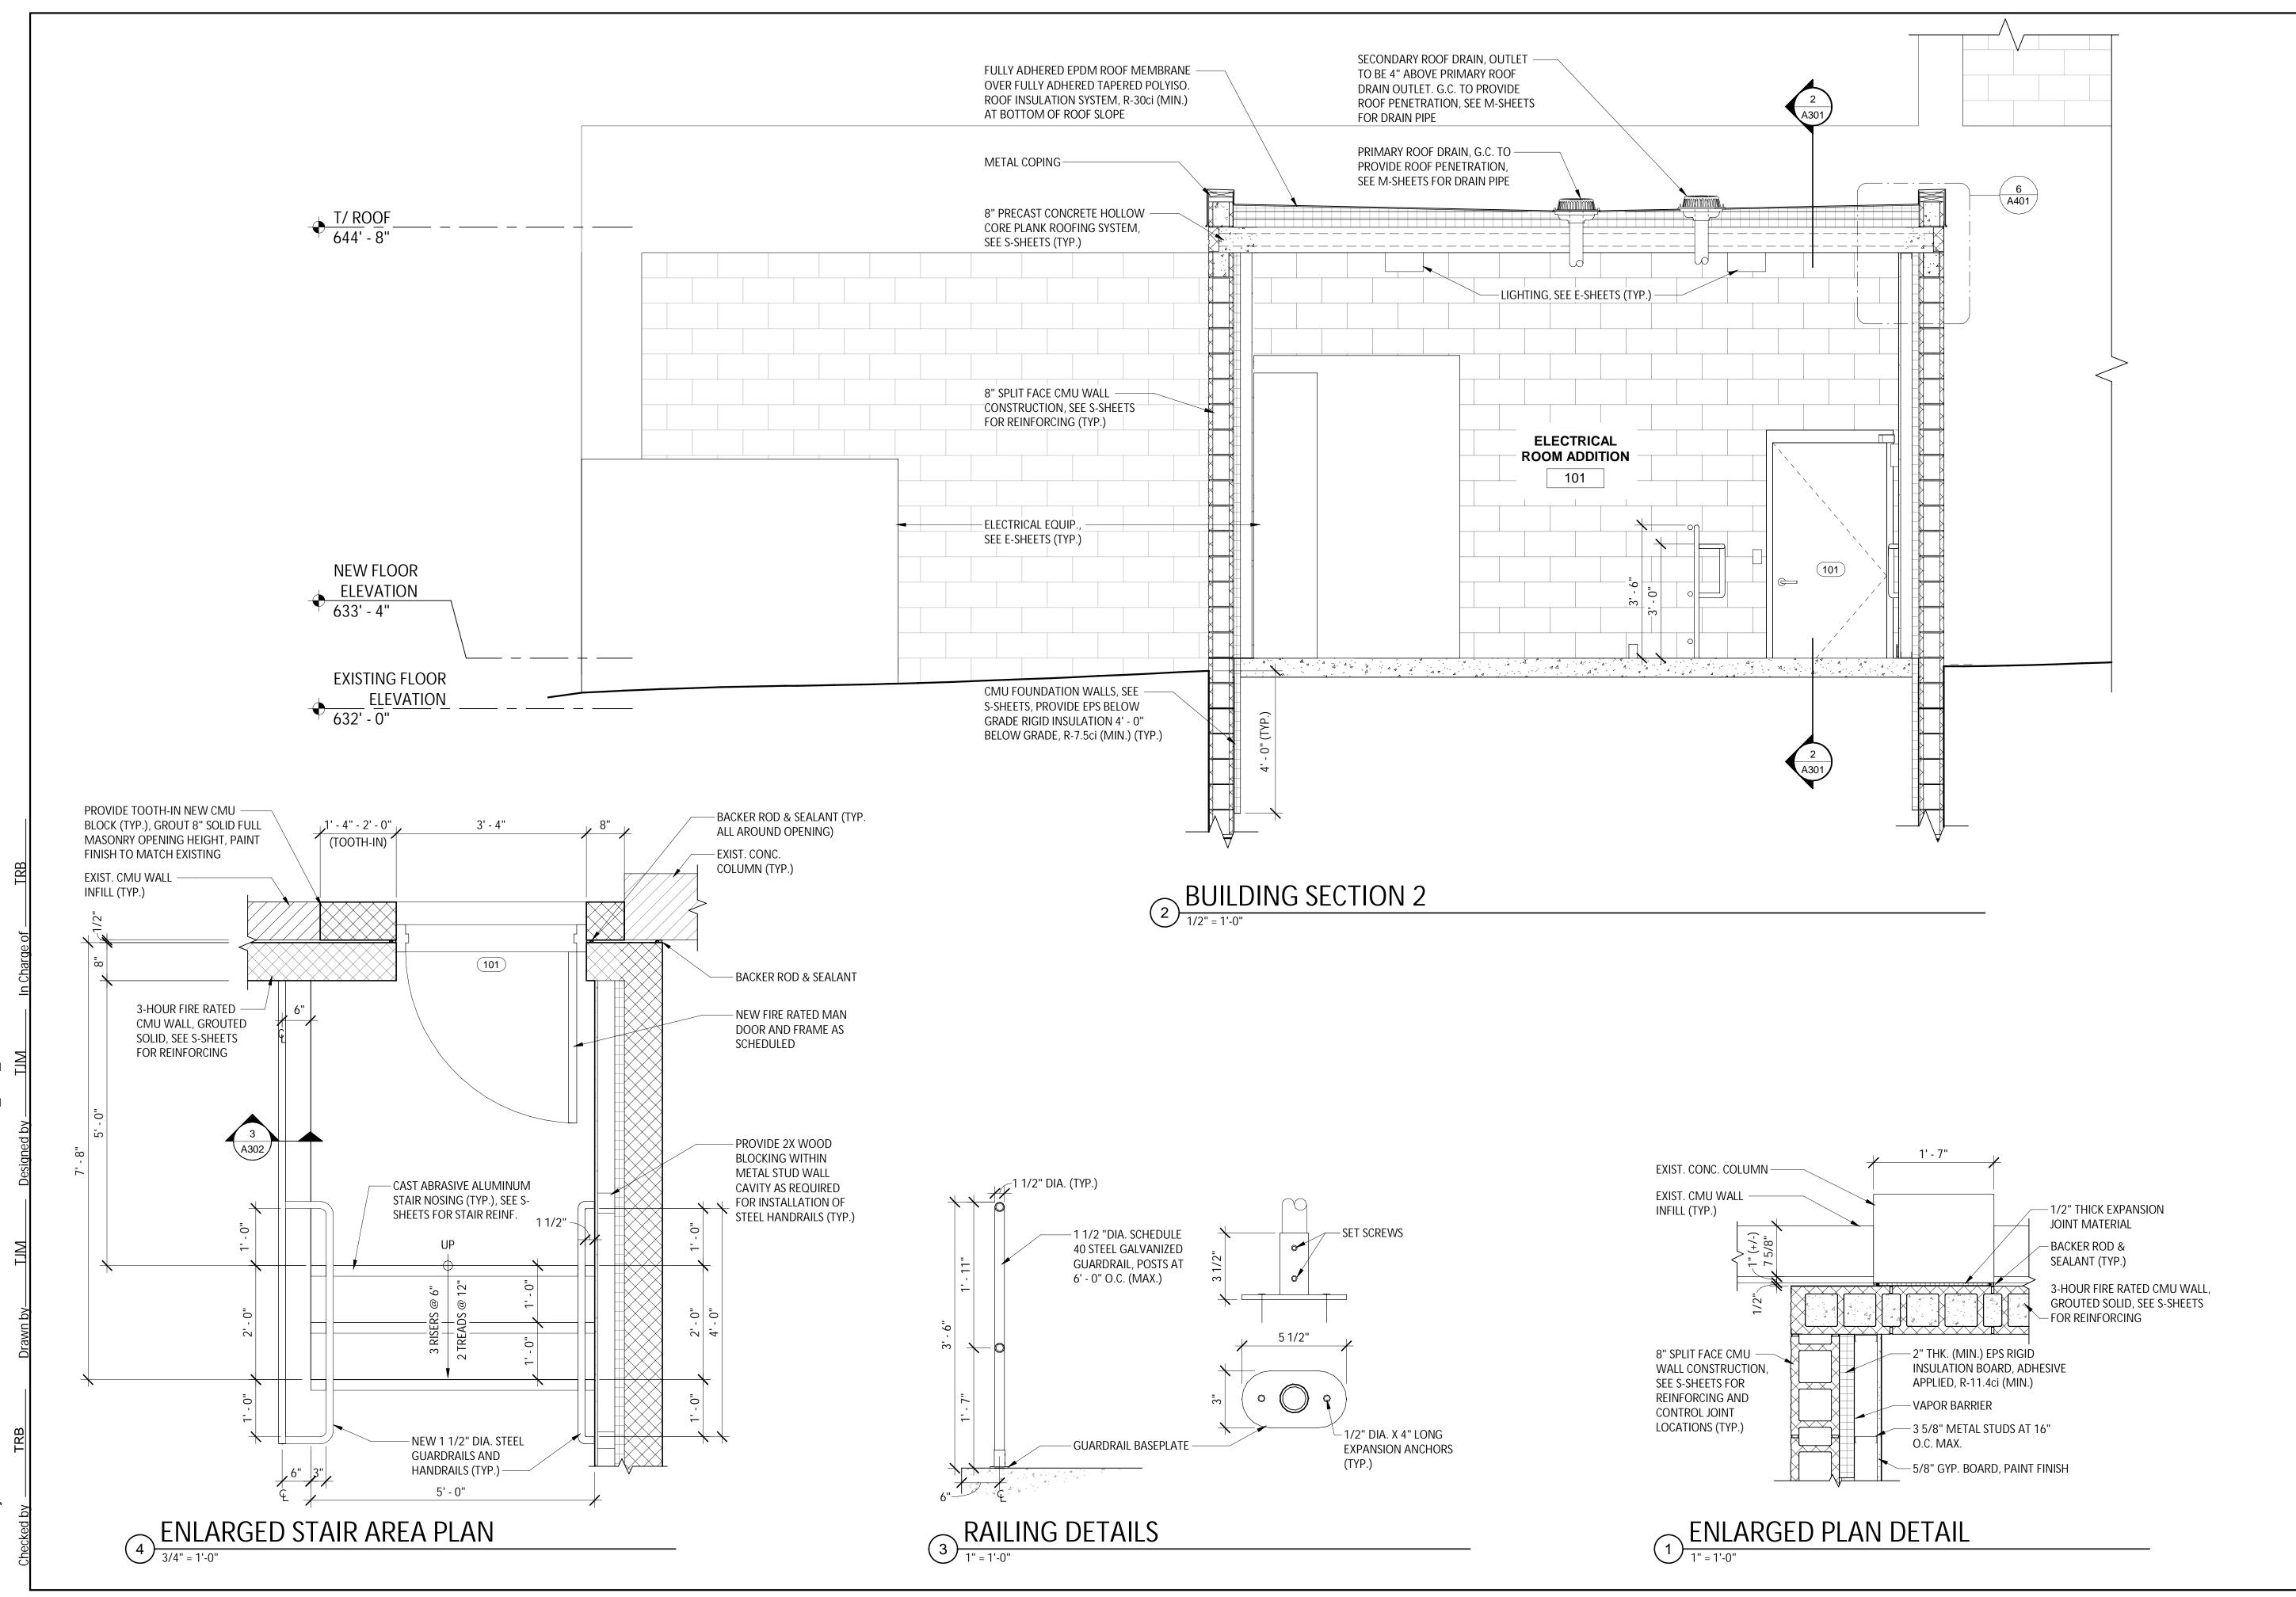
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REVISIONS

AND **PLANS**

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DETAILS

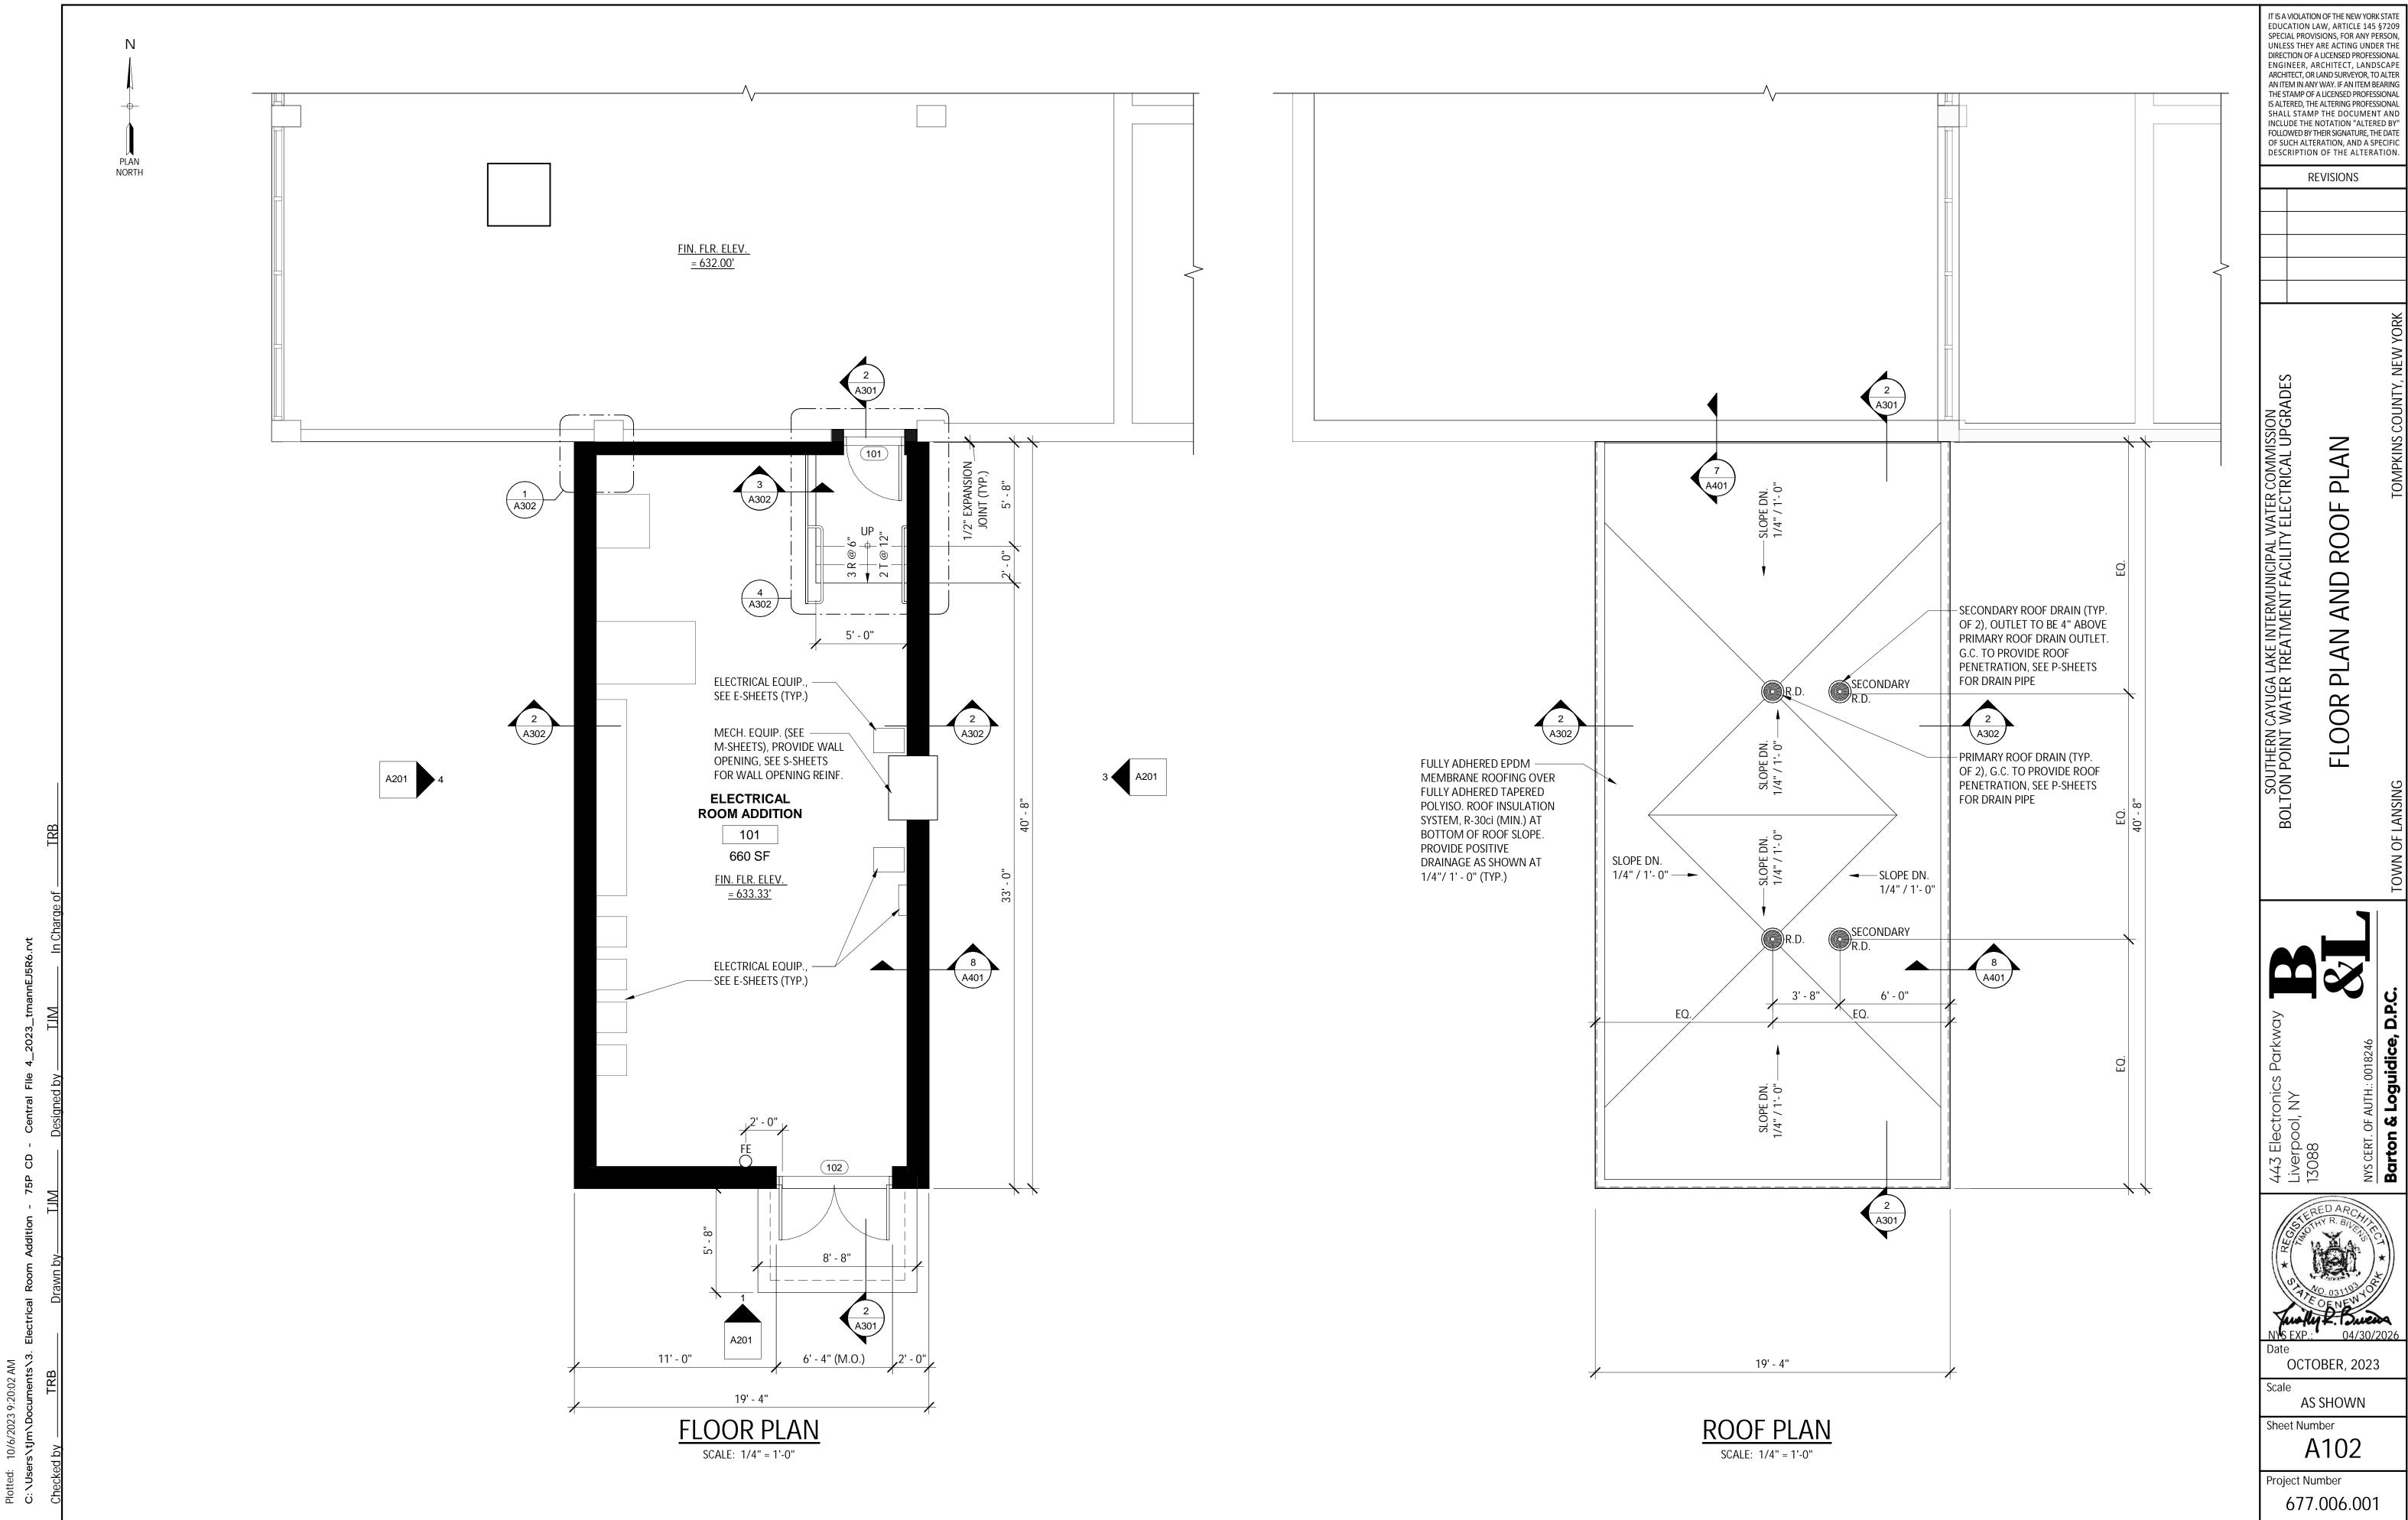
SOUTHERN CAYUGA LAKE INTERMUNICIPAL WATER COMMISSION BOLTON POINT WATER TREATMENT FACILITY ELECTRICAL UPGRADES

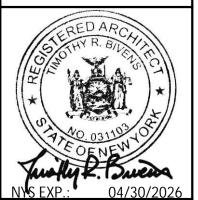SECTION BUILDING

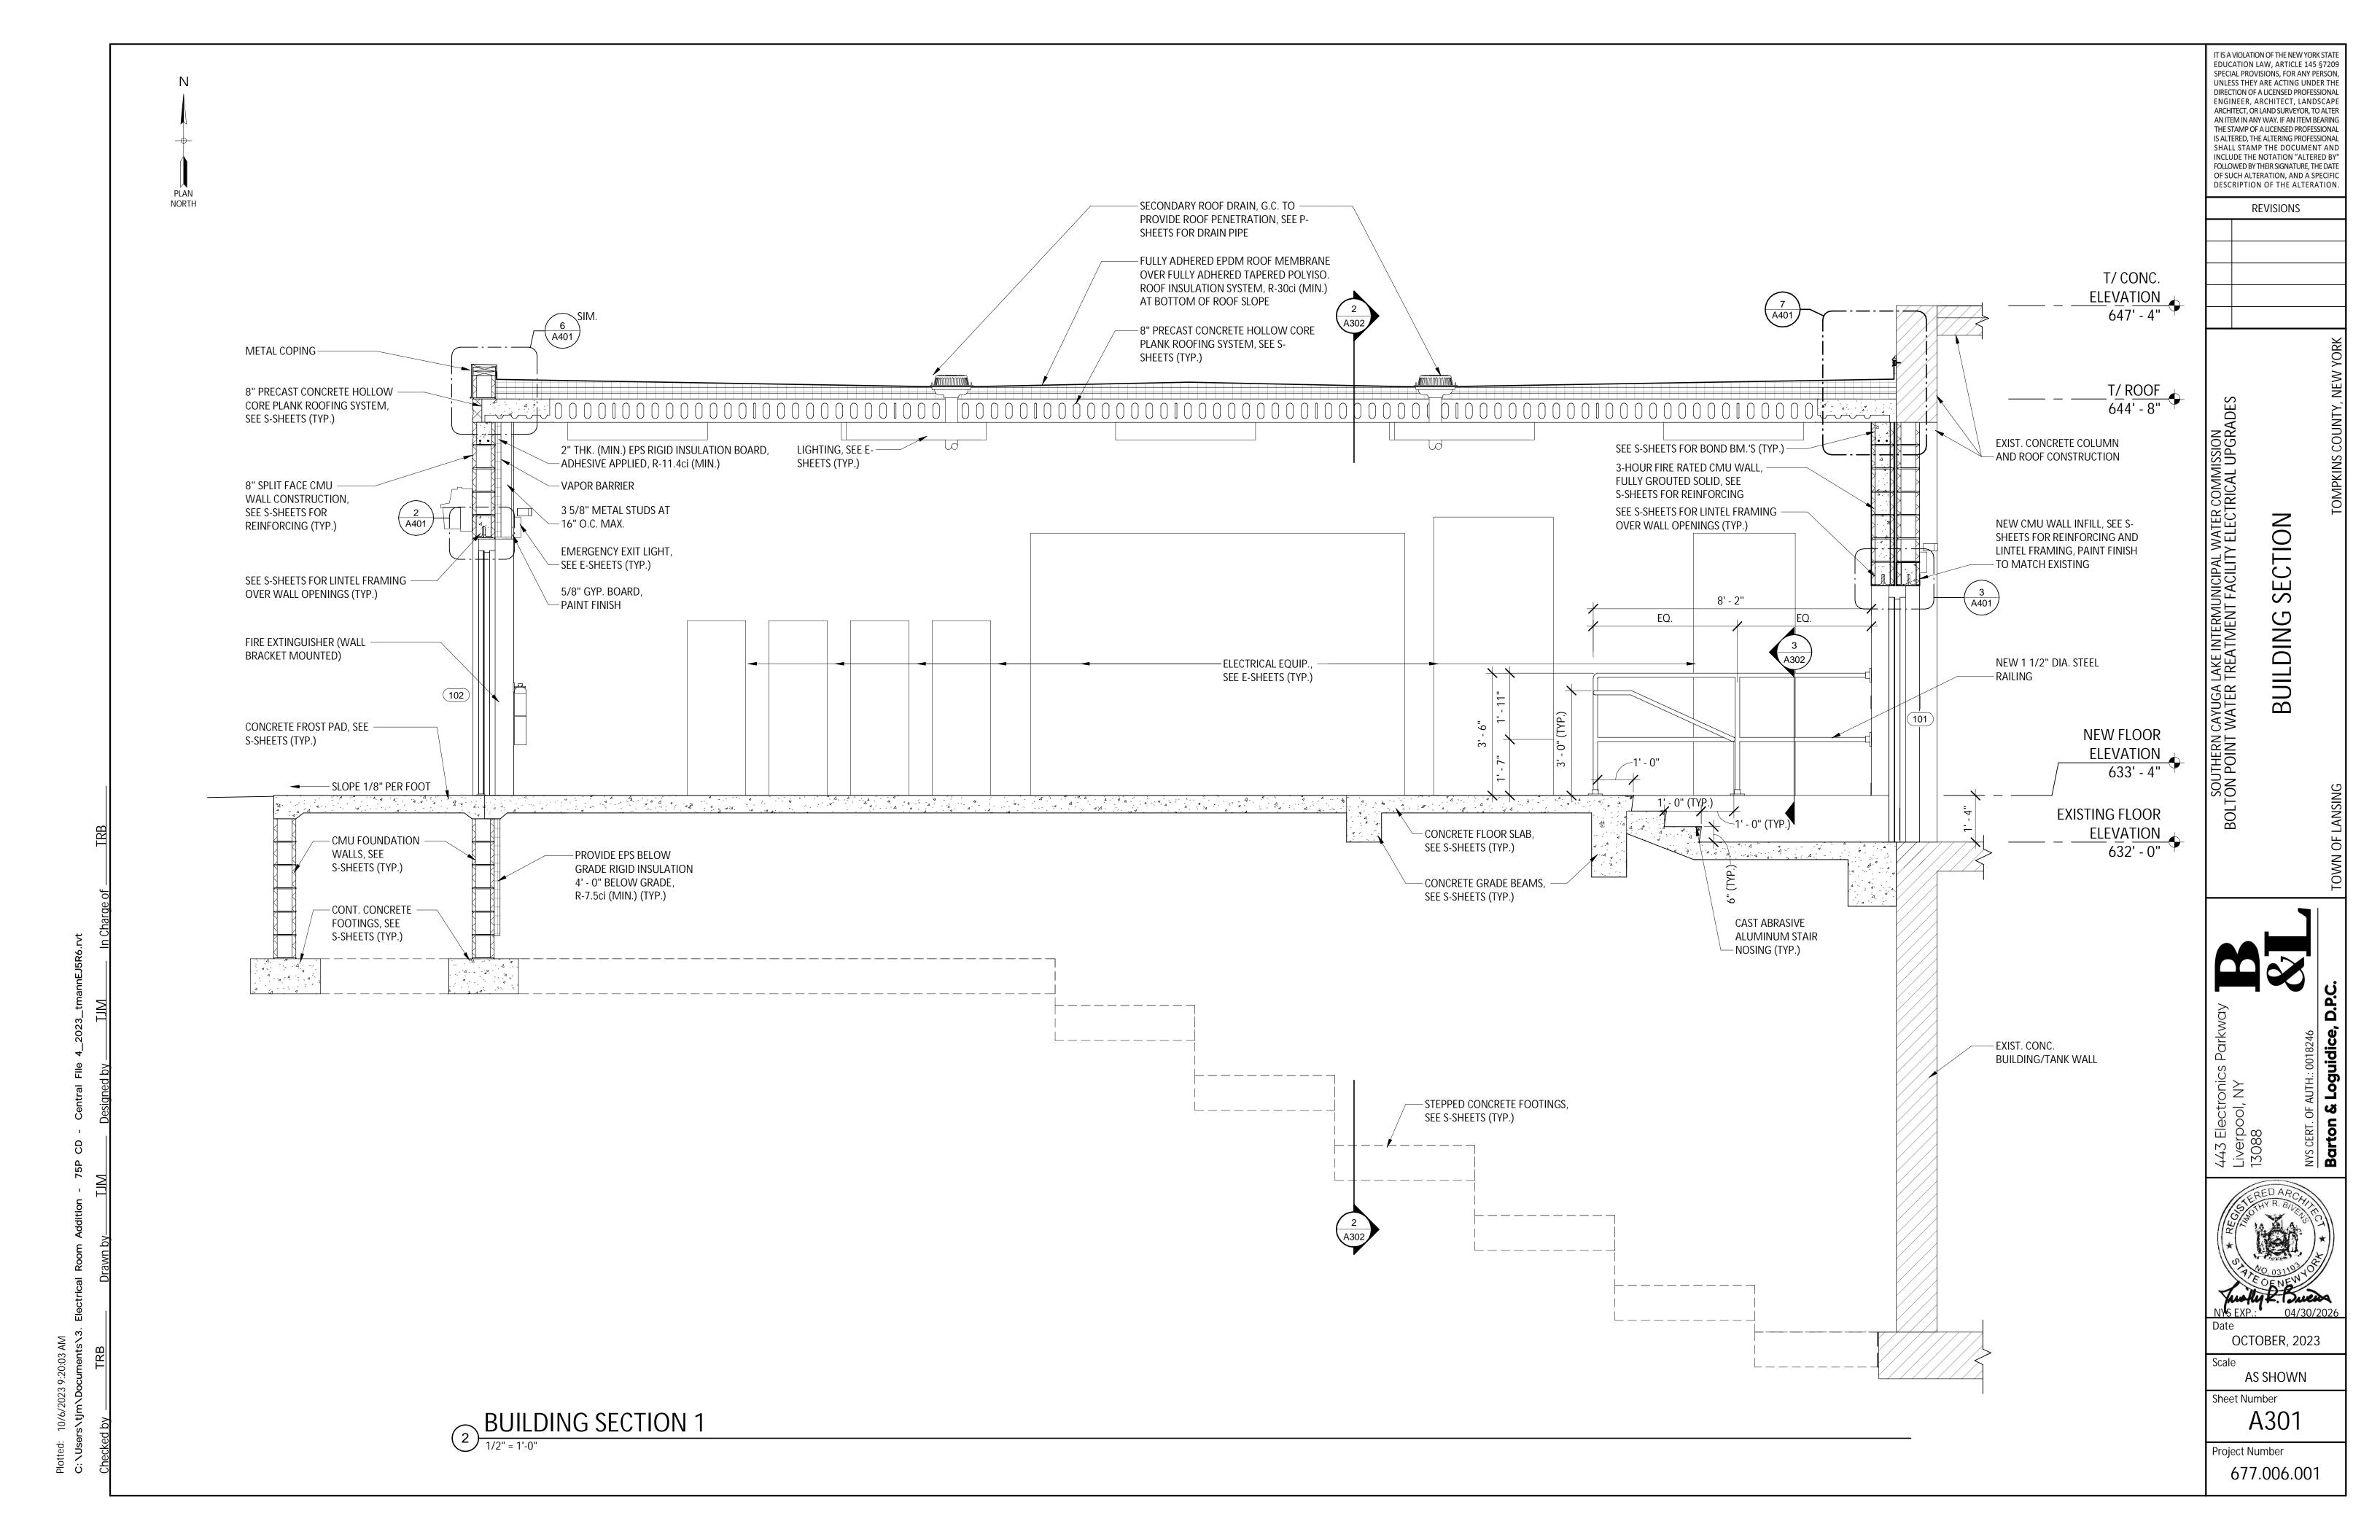OCTOBER, 2023

AS SHOWN

Sheet Number A302

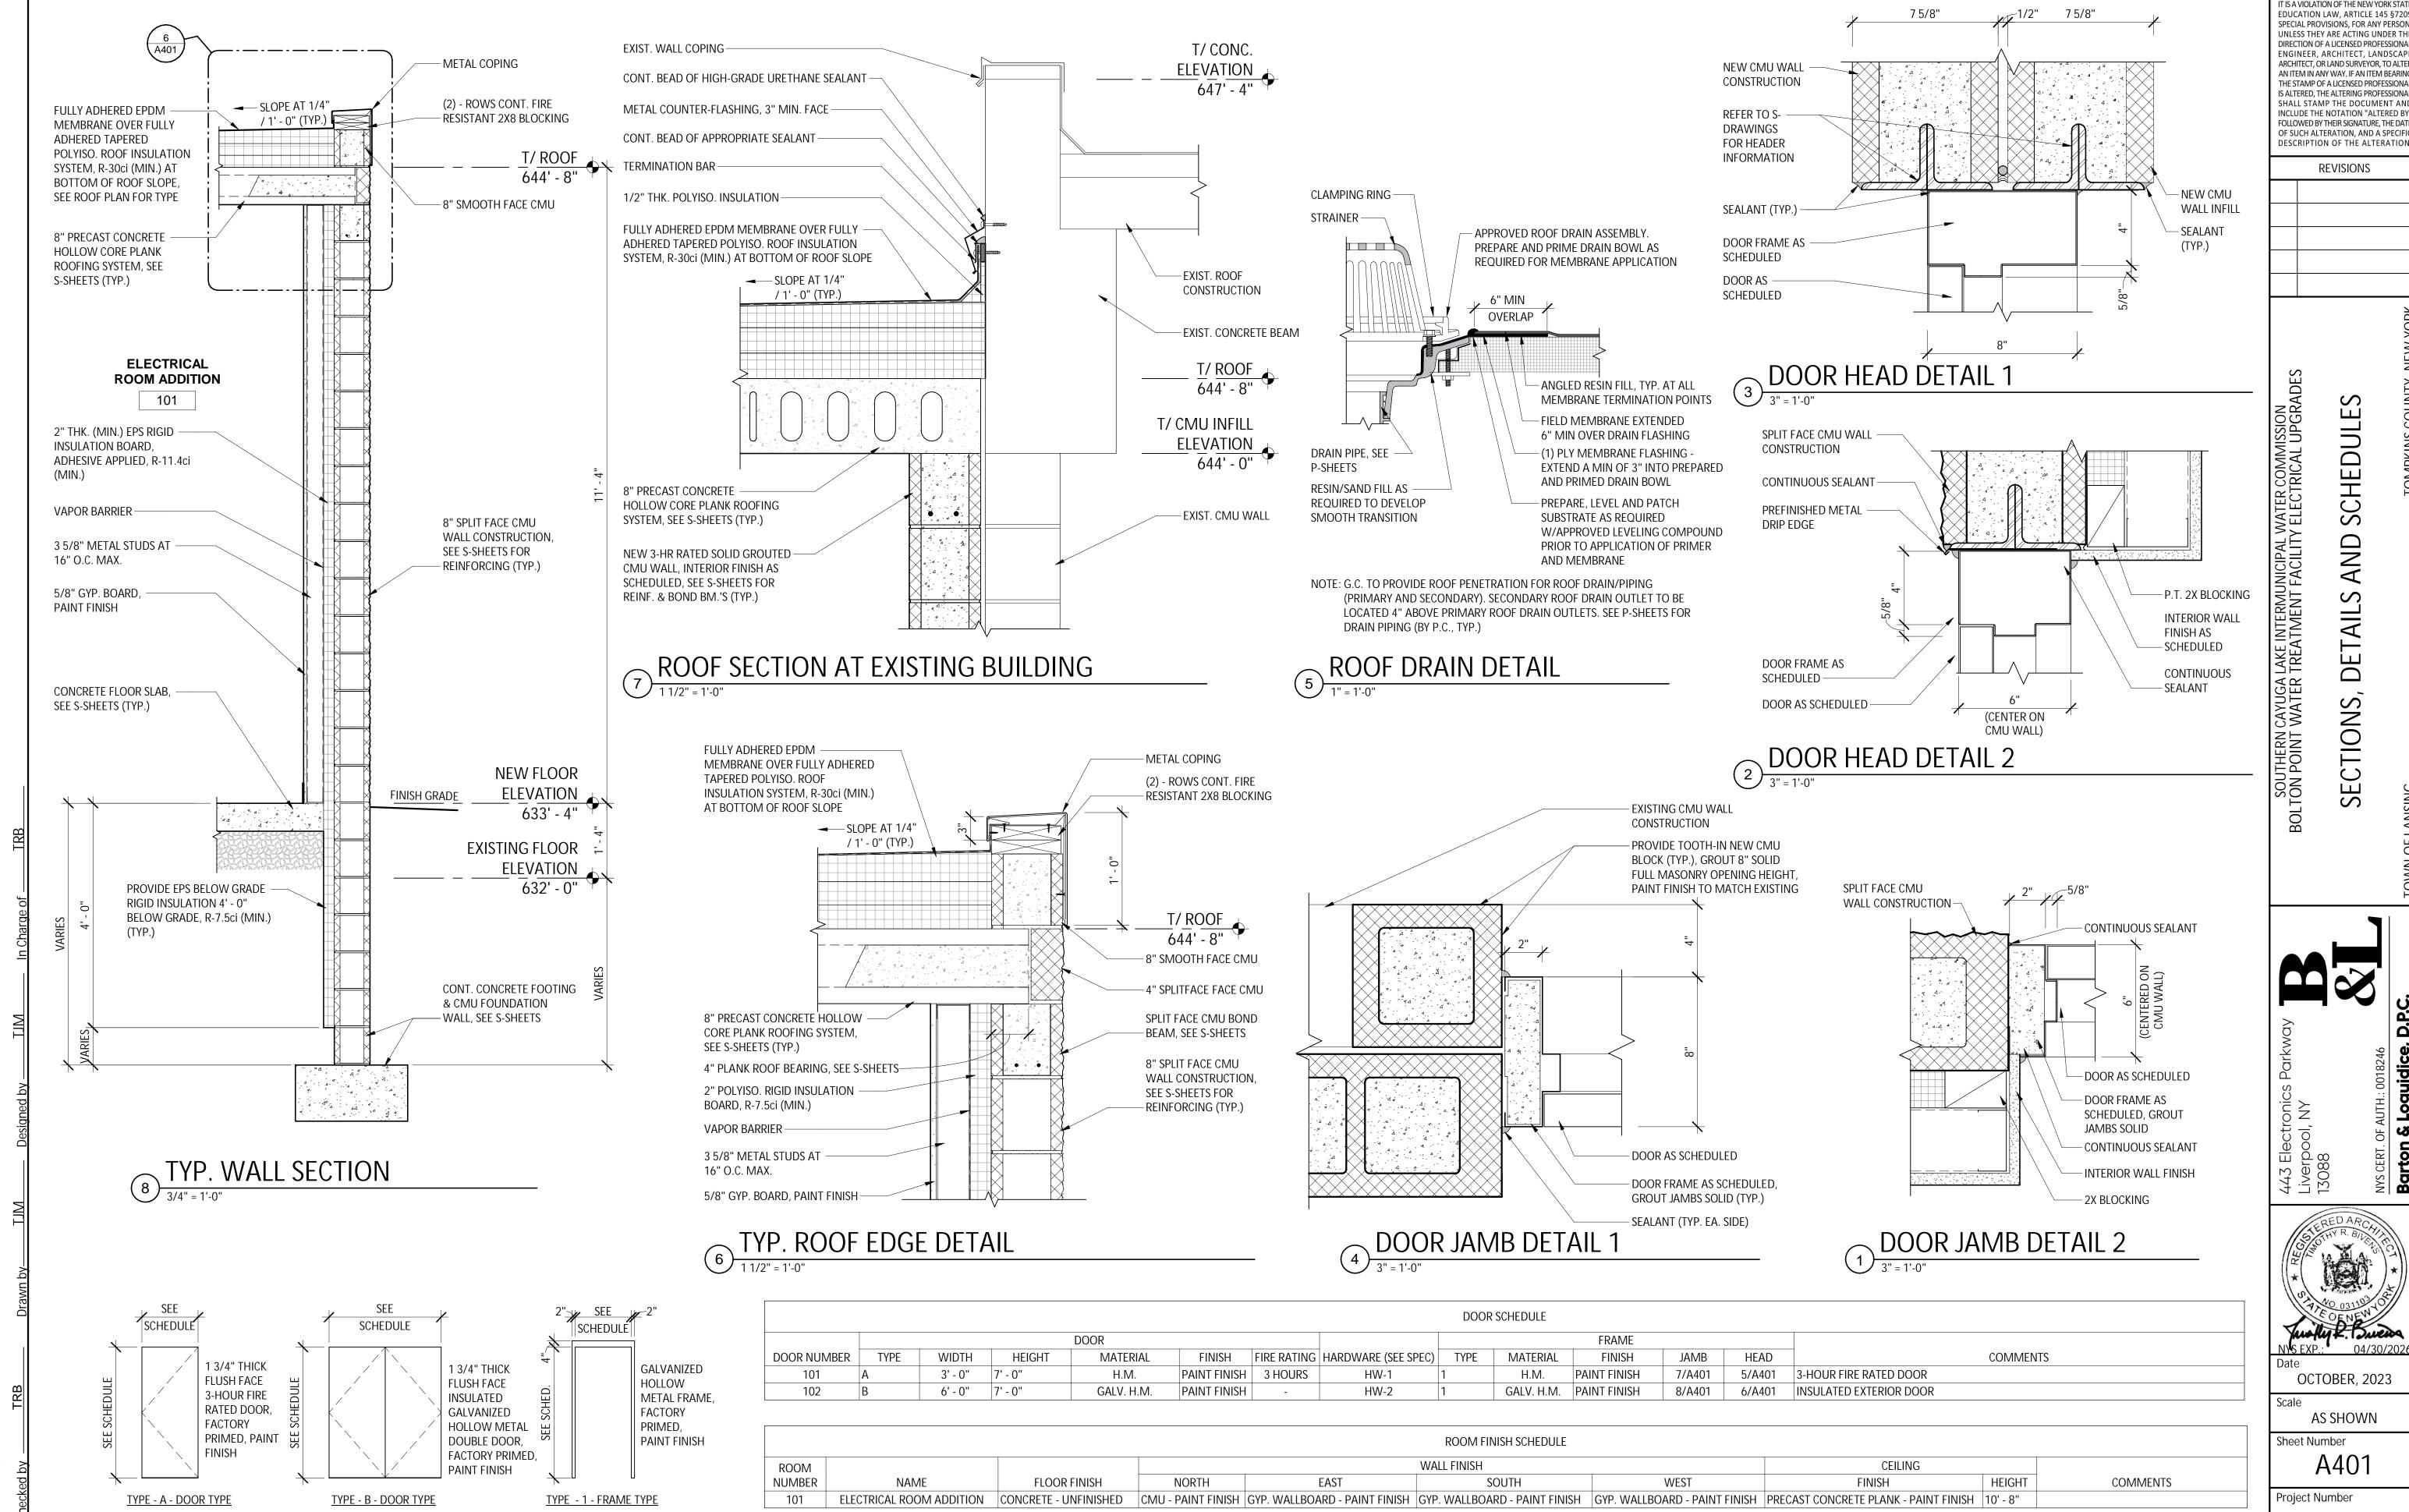

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DESCRIPTION OF THE ALTERATION REVISIONS

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CAYUGA I WATER SECTIONS

OCTOBER, 2023

AS SHOWN

Sheet Number A401

RISK CATEGORY:

DESIGN LOADS:

FLOOR LIVE LOADS:

ALL ROOMS

ROOF LIVE LOADS: MINIMUM ROOF LIVE LOAD 20 PSF

ROOF SNOW LOAD DATA:

 $P_g = 40 PSF$ GROUND SNOW LOAD, SNOW LOAD IMPORTANCE FACTOR, $I_s = 1.00$ SNOW EXPOSURE FACTOR, $C_{e} = 1.00$ $C_t = 1.00$ THERMAL FACTOR, FLAT ROOF SNOW LOAD: $P_f = 28 PSF$ $C_s = 1.0$ SLOPE FACTOR,

WIND DESIGN DATA:

SLOPED ROOF SNOW LOAD:

BASIC DESIGN WIND SPEED, V = 110 MPH WIND EXPOSURE CATEGORY: INTERNAL PRESSURE COEFFICIENT, GCPI: +/- 0.18

DESIGN WIND PRESSURES FOR COMPONENTS AND CLADDING:

1) NEGATIVE VALUES INDICATE LOADS AWAY FROM SURFACE 2) VALUES ARE BASED ON 10 SF SEE ASCE 7-16 CH 31 FOR AREAS

150 PSF

 $p_S = 28 PSF$

LARGER THAN 10 SF COMPONENTS & CLADDING (10 SF)

ROOF:

ZONE 1: 16 PSF / -42.0 PSF ZONE 1': 16 PSF / -24.1 PSF ZONE 2': 16 PSF / -55.4 PSF ZONE 3: 16 PSF / -75.5 PSF

WALL: ZONE 4: 24.1 PSF / -26.2 PSF ZONE 5: 24.1 PSF / -32.2 PSF

EARTHQUAKE DESIGN DATA:

 $I_e = 1.00$ SEISMIC IMPORTANCE FACTOR, MAPPED SPECTRAL RESPONSE ACCELERATION PARAMETERS: S_S: 0.14 S₁: 0.042

S_{DS}: 0.075 DESIGN SPECTRAL RESPONSE ACCELERATION PARAMETERS: S_{D1}: 0.027

SEISMIC DESIGN CATEGORY, SDC: A BASIC SEISMIC FORCE-RESISTING SYSTEM: ORDINARY UN-REINFORCED SHEAR MASONRY BEARING WALL

ANALYSIS PROCEDURE USED: **EQUIVALENT LATERAL-FORCE ANALYSIS** SEISMIC RESPONSE COEFFICIENT $C_S = 0.042$ RESPONSE MODIFICATION COEFFICIENT, R = 2.0V = 6.2 K

DESIGN BASE SHEAR, V:

ALLOWABLE SOIL BEARING = 3,500 PSF

GENERAL STRUCTURAL NOTES:

GEOTECHNICAL DATA:

- 1. STRUCTURAL DRAWINGS SHALL BE FOLLOWED WITH COORDINATION WITH OTHER DRAWINGS. ANY APPARENT DISCREPANCIES SHALL BE BROUGHT TO THE ATTENTION OF THE STRUCTURAL ENGINEER FOR CLARIFICATION PRIOR TO PROCEEDING ON SAID WORK.
- NO CHANGES OF THE STRUCTURAL SYSTEM AS INDICATED ON THESE DRAWINGS SHALL BE PERFORMED PRIOR TO RECEIVING WRITTEN APPROVAL FROM THE STRUCTURAL ENGINEER.
- THESE DRAWINGS DO NOT IDENTIFY COMPONENTS REQUIRED FOR CONSTRUCTION SAFETY. CONTRACTOR
- SHALL BE RESPONSIBLE TO IDENTIFY AND PROVIDE COMPONENTS REQUIRED FOR CONSTRUCTION SAFETY.
- CONTRACTOR SHALL FIELD VERIFY ALL DIMENSION AND ELEVATIONS PRIOR TO STARTING CONSTRUCTION.
- CONTRACTOR SHALL BE RESPONSIBLE FOR TEMPORARILY BRACING AND MAINTAINING THE STABILITY OF
- THE EXISTING STRUCTURE DURING CONSTRUCTION. STRUCTURE SHALL BE ASSUMED UNSTABLE UNTIL COMPONENTS AND ALL CONNECTIONS ARE INSTALLED.
- CONTRACTOR SHALL SUBMIT A DETAILED PLAN FOR SHORING, BRACING AND PROTECTION OF THE EXISTING CONSTRUCTION. THE PLAN SHALL INCLUDE CONSTRUCTION SEQUENCE, BEAR THE SEAL OF A PROFESSIONAL ENGINEER REGISTERED IN THE STATE OF **NEW YORK**, AND BE SUBMITTED TO THE ENGINEER OF RECORD FOR REVIEW PRIOR TO THE BEGINNING OF WORK.
- SECTIONS AND DETAILS ON THESE DRAWINGS ARE TO BE CONSIDERED TYPICAL FOR SIMILAR CONSTRUCTION NOT FULLY DETAILED.
- CONTRACTOR SHALL BE RESPONSIBLE TO PROTECT THE EXISTING FACILITY AND ACCESSORIES. ANY DAMAGE CAUSED BY THE CONTRACTOR SHALL BE REPAIRED OR REPLACED TO THE SATISFACTION OF THE OWNER.
- PROVIDED REFERENCE DATUM ARE NOT RELATED TO ACTUAL SURVEY ELEVATIONS.

EARTHWORK AND FOUNDATIONS NOTES:

FOOTING BEFORE PLACING OF CONCRETE.

- FOUNDATION DESIGNS ARE BASED ON GEOTECHNICAL EVALUATION REPORT PROVIDED BY WMA ENGINEERING, DPC DBA EMPIRE GEOTECHNICAL ENGINEERING SERVICES IN REPORT NO. WB-22-140 (REF. SJB NO. BE-22-140) DATED DECEMBER 2, 2022.
- ALL FOUNDATIONS SHALL BE CONSTRUCTED ON APPROVED STRUCTURAL FILL OR BEDROCK.
- REMOVE ALL UNSUITABLE MATERIAL INCLUDING WOOD FRAGMENTS, GLASS, BRICK, AND ORGANICS WITHIN FIVE FEET OF THE SPECIFIED FOUNDATIONS. REPLACE UNSUITABLE FILL MATERIALS ENCOUNTERED IN FOOTING EXCAVATIONS WITH STRUCTURAL FILL PROPERLY PLACED AND COMPACTED.
- CONTRACTOR SHALL ALLOW OWNER'S REPRESENTATIVE TO VERIFY ACCEPTABLE SUBGRADE CONDITIONS PRIOR TO PLACEMENT OF STRUCTURAL FILL AND/OR CONSTRUCTION OF FOUNDATIONS AND SLABS-ON-GRADE.
- EXPOSED SUBGRADE IN OPEN EXCAVATIONS SHALL BE PROTECTED FROM RAIN AND/OR GROUNDWATER THAT COULD COMPROMISE THEIR CONDITION. CONTRACTOR SHALL PROVIDE COVER AND/OR CASTING OF 3-INCH CLSM MUDMAT AS NEEDED. FOOTING SUBGRADES THAT BECOME SATURATED AND UNSTABLE SHALL BE OVEREXCAVATED AND REPLACED WITH 6-INCH LAYER OF NYSDOT NUMBER 2 CRUSHED STONE COMPACTED PER THE PROJECT DOCUMENTS AND ON-SITE GEOTECHNICAL TESTING AGENCY.
- FOUNDATIONS SHALL NOT BE CAST ON FROZEN SUBGRADE OR FROZEN STRUCTURAL FILL MATERIAL. DO NOT PLACE STRUCTURAL FILL ON FROZEN SUBGRADE.
- ALL EXCAVATIONS SHALL BE DEWATERED AS NECESSARY TO MAINTAIN GROUNDWATER AT LEAST 24" BELOW
- ALL EXCAVATIONS INTO UNDISTURBED SOILS SHALL BE PROOF ROLLED USING A VIBRATORY SMOOTH DRUM ROLLER WEIGHING AT LEAST 10 TONS.
- ALL STRUCTURAL FILL SHALL BE PLACED IN MAXIMUM 8-INCH LIFTS (AND AS DIRECTED BY THE ON-SITE SOILS TESTING AGENCY), COMPACTED TO 95% OF THE MATERIAL'S MAXIMUM DRY DENSITY AS DETERMINED BY ASTM D1557. IN-PLACE DENSITY SHALL BE DETERMINED BY ASTM D 6938. SEE SPECIFICATIONS FOR COMPACTION AND FIELD TESTS.
- REFER TO THE PROJECT SUBSURFACE INVESTIGATION AND GEOTECHNICAL EVALUATION FOR ADDITIONAL SPECIFIC RECOMMENDATIONS.

CONCRETE NOTES:

- ALL CONCRETE SHALL BE BATCHED, TRANSPORTED, CONVEYED, PLACED, CURED, AND TESTED IN ACCORDANCE WITH ACI 350.
- ALL EXTERIOR CONCRETE EXPOSED TO DEICING CHEMICALS (INCLUDING APRONS, SIDEWALKS, CURBS, ETC.) SHALL BE AIR ENTRAINED AND HAVE A MINIMUM 28-DAY COMPRESSIVE STRENGTH OF 5,000 PSI.
- ALL REINFORCING STEEL BARS SHALL BE ASTM A615, GRADE 60 DEFORMED BARS.
- WELDED WIRE REINFORCEMENT (WWR) SHALL BE SUPPLIED IN SHEETS CONFORM ING TO ASTM A1064. LAP SPLICE WWR SHEETS MINIMUM 6 INCHES.
- CLEAR CONCRETE COVER OVER REINFORCING BARS SHALL CONFORM TO THE REQUIREMENTS OF ACI 318 AND AS FOLLOWS;
 - CONCRETE EXPOSED TO EARTH, WEATHER, OR WATER: 2" - CONCRETE CAST DIRECTLY AGAINST EARTH:
- CONCRETE FINISHES AND CURING:
- ALL EXPOSED FACES OF CONCRETE SHALL BE RUBBED FINISH (UNLESS NOTED OTHERWISE)
- EXTERIOR WALKING SURFACES (INCLUDING SLABS AND SIDEWALKS) SHALL BE LIGHTLY TROWELED AND RECEIVE A BROOM FINISH (APPLIED PERPENDICULAR TO THE LINE OF TRAVEL).
- ALL STRUCTURAL CONCRETE SHALL ATTAIN THE SPECIFIED CONCRETE STRENGTH PRIOR TO LOADING.
- INTERIOR AND EXTERIOR SLABS, SIDEWALKS, AND OTHER WALKING SURFACES SHALL BE COATED WITH A PENETRATING SEALER. SUBMIT SEALER FOR APPROVAL PRIOR TO USE.
- APPLY BONDING AGENT PRIOR TO CASTING CONCRETE AGAINST HARDENED CONCRETE, UNLESS INDICATED OTHERWISE.
- ALL EXPOSED EDGES OF CONCRETE MEMBERS SHALL BE FORMED WITH A 3/4" BY 3/4" CHAMFER, INCLUDING TOP EDGES AND OUTSIDE VERTICAL CORNERS OF WALLS, SLABS, BEAMS, COLUMNS, ETC. (STAIR TREADS NOT INCLUDED).
- ALL EXTERIOR SLABS AND FLATWORK SHALL HAVE 1/4" PER FOOT (1/8" PER FOOT MINIMUM) SURFACE SLOPE IN ORDER TO PROVIDE POSITIVE DRAINAGE.
- CONTRACTOR SHALL PROVIDE CONSTRUCTION JOINTS AND CONTROL JOINTS AS INDICATED ON THESE DRAWINGS. CONTRACTOR MAY PROPOSE ADDITIONAL CONSTRUCTION JOINTS NEEDED TO FACILITATE CONSTRUCTION. ALL ADDITIONAL CONSTRUCTION JOINTS SHALL BE APPROVED BY THE STRUCTURAL ENGINEER PRIOR TO CONSTRUCTING.
- VERTICAL JOINTS IN FOUNDATION WALLS FROST WALLS SHALL LINE UP WITH MASONRY BLOCK (CMU) CONTROL
- APPLY BONDING AGENT PRIOR TO CASTING CONCRETE AGAINST HARDENED CONCRETE, EXCEPT ALONG
- CONTRACTOR SHALL COORDINATE ALL WALL AND SLAB PENETRATIONS AND OPENINGS WITH OTHER TRADES. NOTE THAT NOT ALL PENETRATIONS AND OPENINGS ARE INDICATED ON THESE STRUCTURAL DRAWINGS.
- CONTRACTOR SHALL COORDINATE THE CASTING-IN OF ALL EMBEDDED ITEMS AND ACCESSORIES OF ALL
- TRADES. POST-INSTALLATION OF EMBEDDED ITEMS WILL NOT BE ACCEPTED. NON-SHRINK GROUT SHALL BE FLOWABLE, NON-STAINING, CEMENT-BASED PRODUCT THAT IS MANUFACTURED PREMIXED REQUIRING ONLY THE ADDITION OF WATER. GROUT SHALL BE CAPABLE OF ACHIEVING 5,000 PSI IN 7 DAYS AND 7,000 PSI IN 28 DAYS MIXED AT A PLASTIC CONSISTENCY.
- 17. CHEMICAL ADHESIVE SYSTEMS: CHEMICAL ADHESIVE SYSTEMS SHALL BE USED TO INSTALL ALL DRILLED-IN ANCHOR COMPONENTS
 - (BOLTS, DOWELS, ETC,) INTO HARDENED CONCRETE. NO CHEMICAL ADHESIVE SYSTEMS, ANCHORS, BOLTS, DOWELS, ETC. MAY BE INSTALLED EARLIER THAN 7 DAYS AFTER CONCRETE PLACEMENT.
- SUBMIT CHEMICAL ADHESIVE PRODUCT CATALOG CUTS FOR APPROVAL.
- 18. REFER TO DIVISION 03 OF THE SPECIFICATIONS FOR ALL OTHER REQUIREMENTS.

MASONRY NOTES

- ALL MASONRY WALLS SHALL BE REINFORCED. REFER TO REINFORCED MASONRY DETAILS INDICATED ON THESE STRUCTURAL DRAWINGS.
- ALL MASONRY CELLS CONSISTING OF REINFORCING BARS SHALL BE GROUTED SOLID.
- BASE OF WALL DOWELS SHALL BE INSTALLED AT EVERY REINFORCED MASONRY CELL.
- FULLY GROUT ALL CELLS OF MASONRY CONSTRUCTED BELOW GRADE.
- CONTINUOUS BOND BEAMS SHALL BE CONSTRUCTED AT TOP OF MASONRY WALLS THAT SUPPORT A ROOF OR FLOOR SLAB ABOVE. THESE BOND BEAMS SHALL NOT BE INTERRUPTED AT CONTROL JOINTS.
- INFILL MASONRY AROUND ALL EMBEDDED BEAMS AND COLUMNS POCKETED INTO THE WALL.
- LINTELS ARE REQUIRED FOR ALL CMU WALL OPENINGS GREATER THAN 16 INCHES.

STRUCTURAL STEEL NOTES:

- ALL STRUCTURAL STEEL MEMBERS AND CONNECTIONS SHALL BE FABRICATED AND ERECTED IN ACCORDANCE WITH THE CURRENT EDITION OF "SPECIFICATION FOR STRUCTURAL STEEL BUILDINGS" BY THE AMERICAN INSTITUTE OF STEEL CONSTRUCTION, INC. (AISC).
- FABRICATION, WELDING, ERECTION, AND INSPECTION CONFORMS TO THE AISC MANUAL OF STEEL CONSTRUCTION – LATEST EDITION
- MATERIALS FOR STRUCTURAL MEMBERS SHALL CONFORM WITH THE ASTM DESIGNATIONS AS FOLLOWS:
 - ASTM A992, GRADE 50 - W-SHAPES: ASTM A36 (36 KSI)
 - CHANNELS, TEES, & ANGLES: - HOLLOW STRUCTURAL SHAPES (HSS): ASTM A500, GRADE B (46 KSI)
 - ASTM A36 (36 KSI) - STRUCTURAL PLATES:
- ALL FABRICATIONS SHALL CONSIST OF FULLY WELDED CONNECTIONS, UNLESS INDICATED OTHERWISE. ALL WELDING SHALL BE PERFORMED IN ACCORDANCE WITH THE AMERICAN WELDING SOCIETY (AWS) "2010 STRUCTURAL WELDING CODE - STEEL" (AWS D1.1).
- FILLER METAL: AWS 5.1 OR 5.5
- E70XX SMAW WELDING ELECTRODES:
- ALL FIELD WELDS SHALL BE CLEANED, AND SHALL BE PRIMED AND TOP COATED WITH PAINT TO PREVENT FROM RUSTING.
- MATERIALS FOR FASTENERS SHALL CONFORM WITH THE ASTM AND ANSI DESIGNATIONS AS FOLLOWS:
 - STRUCTURAL BOLTS: ASTM A325N ASTM A563 - STRUCTURAL NUTS:
 - STEEL WASHERS: ASTM F436
 - ANCHOR BOLTS (RODS): ASTM F1554 (HOT-DIP GALVANIZED)
- PROVIDE 1/4" FILLET WELDS UNLESS SPECIFIED OTHERWISE WITH E70XX SERIES LOW HYDROGEN
- STEEL BEAM TO BEAM AND BEAM TO COLUMN CONNECTIONS ARE TO BE FULL DEPTH CONNECTIONS MADE WITH 5/16" DOUBLE ANGLES AND MAXIMUM NUMBER OF ¾ INCH DIAMETER A325 BOLTS UNLESS SPECIFIED OTHERWISE.
- ALL BOLTED CONNECTIONS SHALL BE MADE SNUG TIGHT.

ELECTRODES/RODS.

- ALL ANCHOR BOLTS SHALL BE DRILLED INTO THE EXISTING FLOOR SLAB AND SET WITH CHEMICAL ADHESIVE ANCHORING SYSTEM.
- ALL STEEL MEMBERS, COMPONENTS, AND FASTENERS SHALL BE COATED WITH APPROVED EPOXY PAINT
- SUBMIT FULLY DETAILED SHOP FABRICATION DRAWINGS TO STRUCTURAL ENGINEER FOR REVIEW AND APPROVAL PRIOR TO FABRICATION AND ERECTION. VERIFY ALL EXISTING DIMENSIONS AND CONDITIONS PRIOR TO SUBMITTING SHOP DRAWINGS FOR APPROVAL.

SYSTEM. ALL UNPAINTED STRUCTURAL STEEL EXPOSED TO ELEMENTS TO BE HOT DIPPED GALVANIZED.

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NYS EXP. 05/31/202


OCTOBER, 2023

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Project Number

677.006.001

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EDUCATION LAW, ARTICLE 145 §7209 SPECIAL PROVISIONS, FOR ANY PERSON, UNLESS THEY ARE ACTING UNDER THE DIRECTION OF A LICENSED PROFESSIONAL ENGINEER, ARCHITECT, LANDSCAPE ARCHITECT, OR LAND SURVEYOR, TO ALTER AN ITEM IN ANY WAY. IF AN ITEM BEARING THE STAMP OF A LICENSED PROFESSIONAL IS ALTERED, THE ALTERING PROFESSIONAL SHALL STAMP THE DOCUMENT AND INCLUDE THE NOTATION "ALTERED BY FOLLOWED BY THEIR SIGNATURE, THE DATE OF SUCH ALTERATION, AND A SPECIFIC

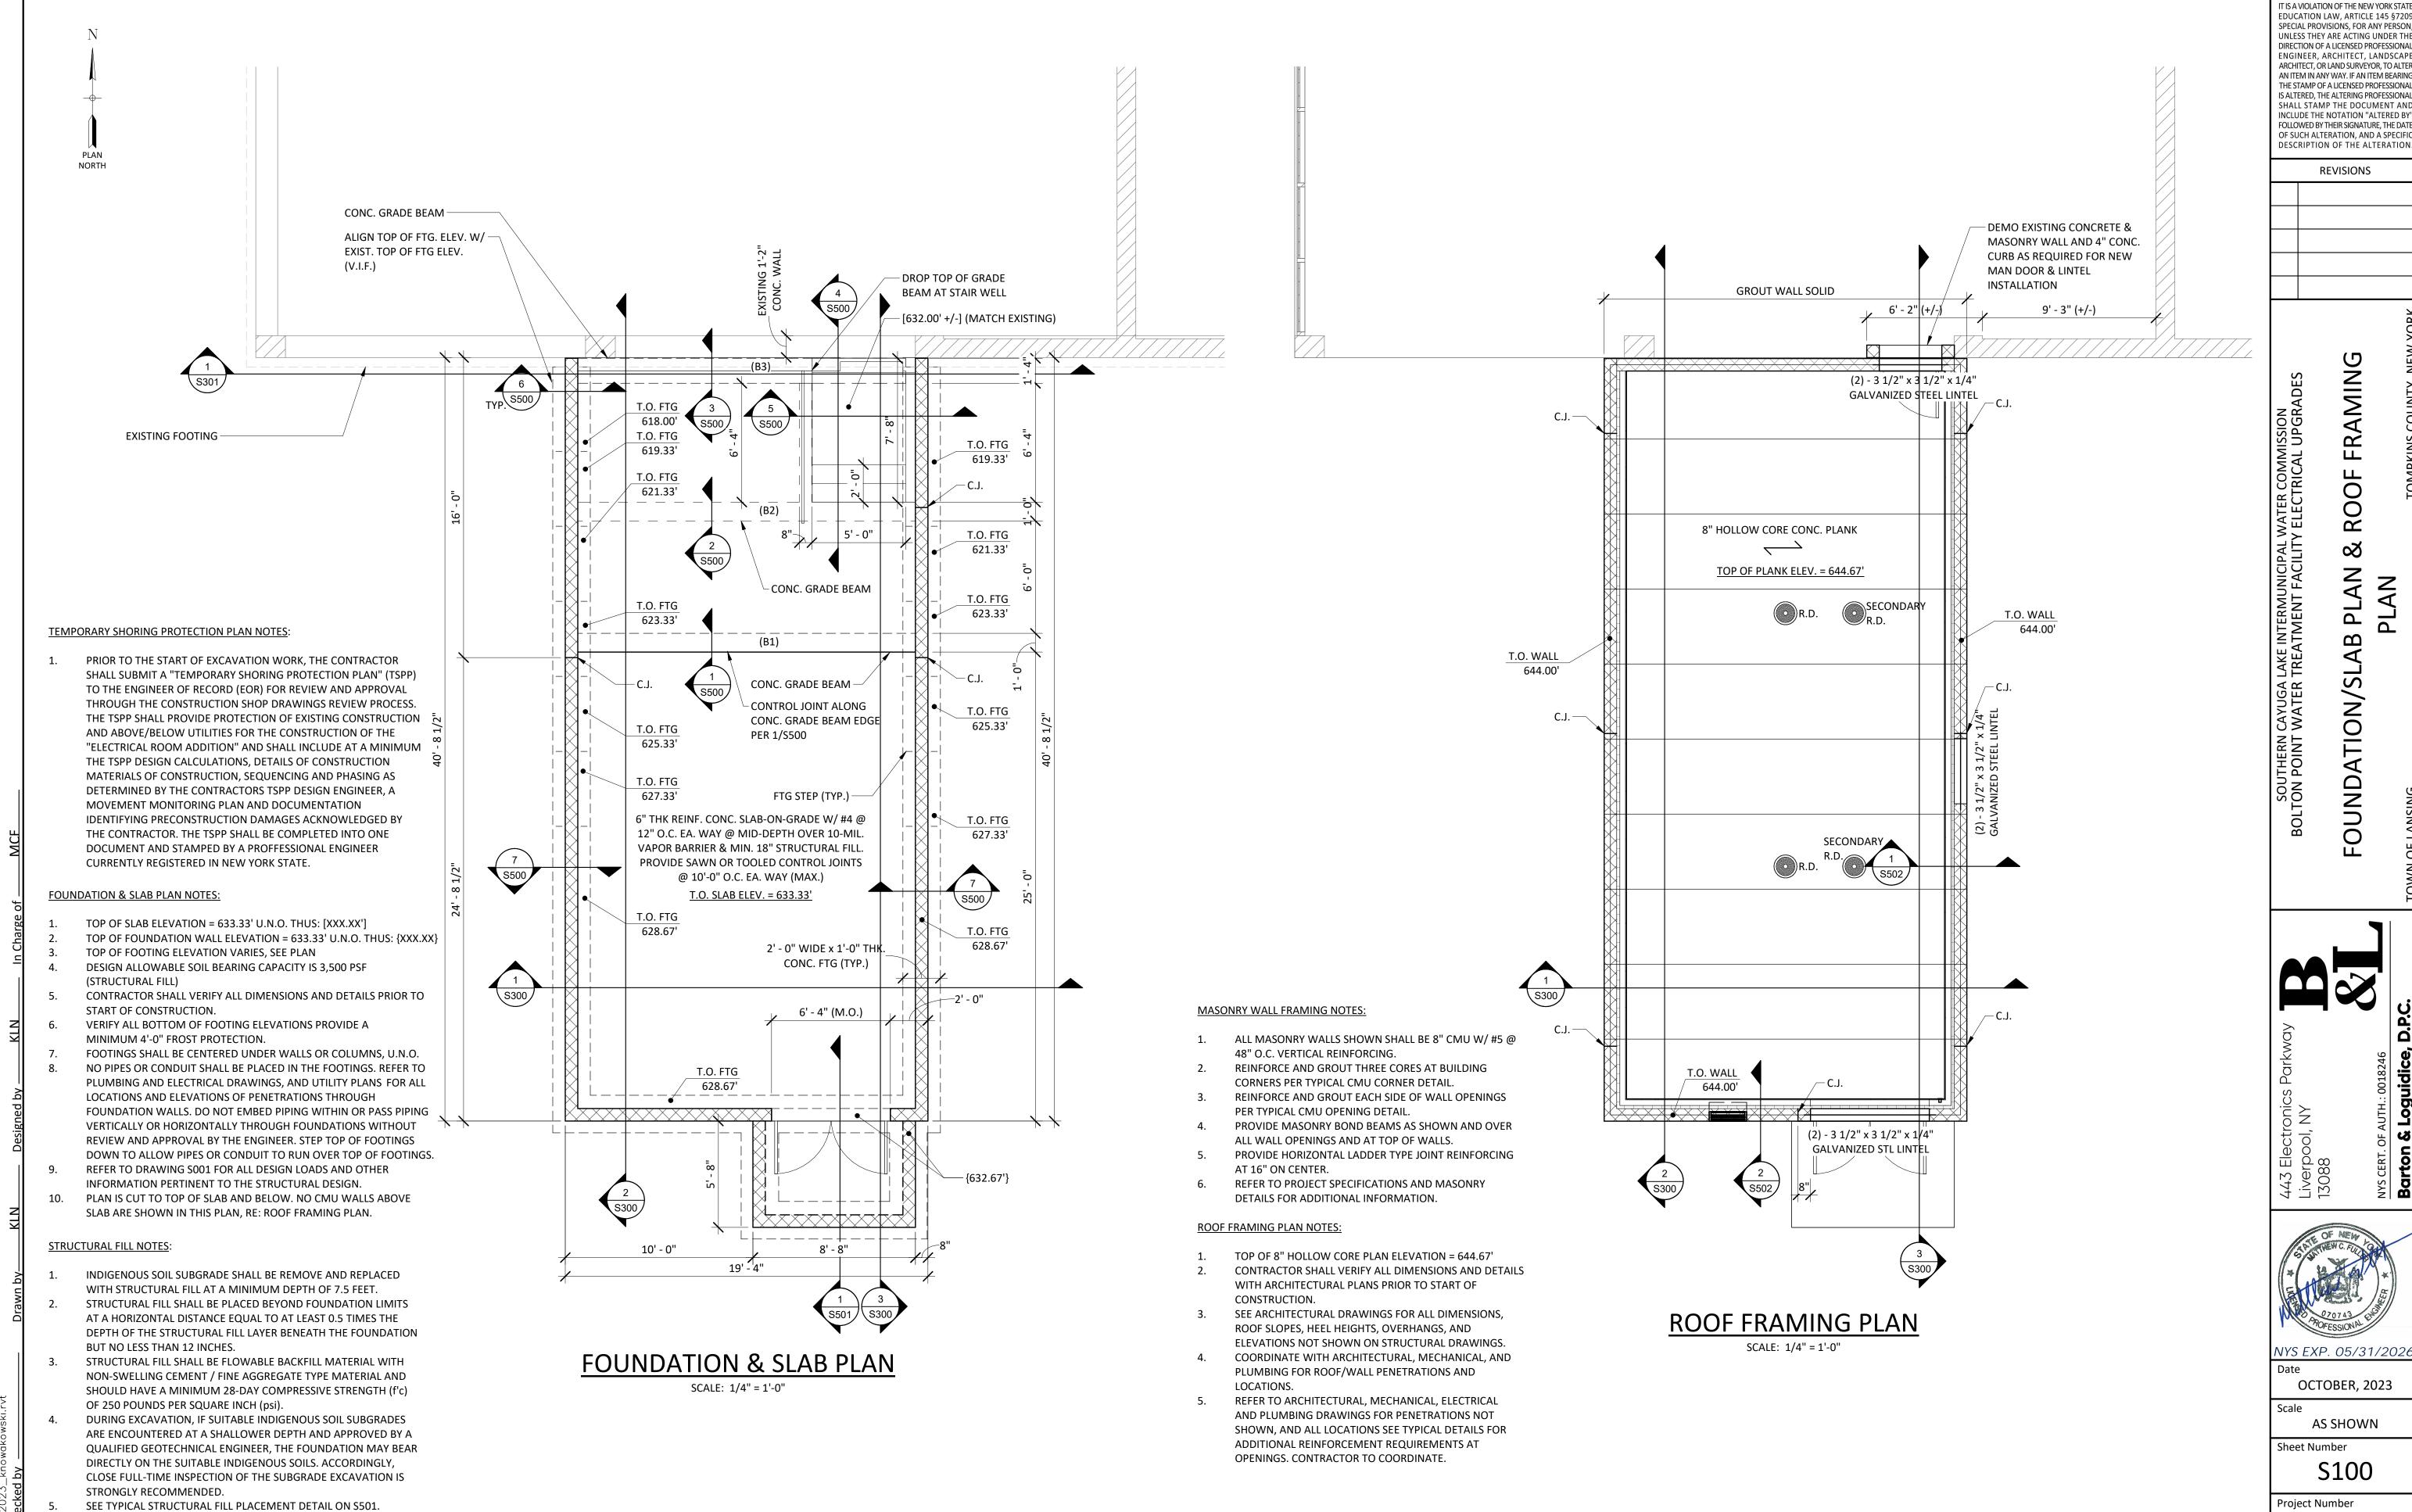

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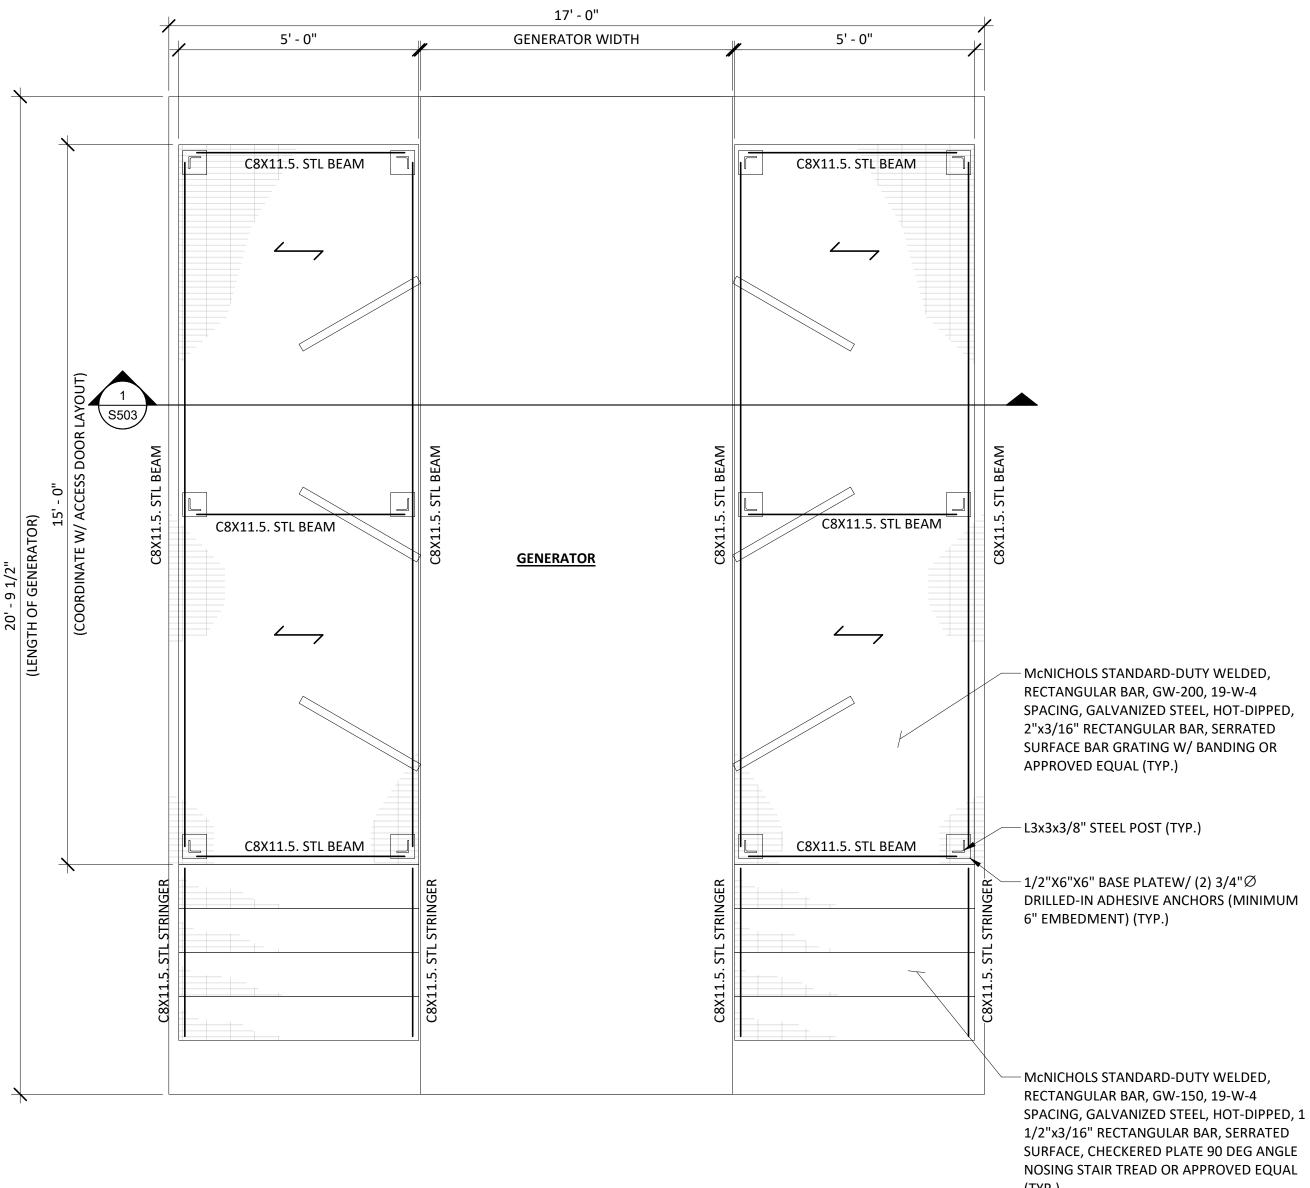
AS SHOWN

GENERATOR FOUNDATION PLAN

SCALE: 1/2" = 1'-0"

STRUCTURAL FILL NOTES:

- 1. INDIGENOUS SOIL SUBGRADE SHALL BE REMOVE AND REPLACED WITH STRUCTURAL FILL
- AT A MINIMUM DEPTH OF 7.5 FEET. 2. STRUCTURAL FILL SHALL BE PLACED BEYOND FOUNDATION LIMITS AT A HORIZONTAL
- DISTANCE EQUAL TO AT LEAST 0.5 TIMES THE DEPTH OF THE STRUCTURAL FILL LAYER BENEATH THE FOUNDATION BUT NO LESS THAN 12 INCHES.
- STRUCTURAL FILL SHALL BE FLOWABLE BACKFILL MATERIAL WITH NON-SWELLING CEMENT / FINE AGGREGATE TYPE MATERIAL AND SHOULD HAVE A MINIMUM 28-DAY COMPRESSIVE STRENGTH (f'c) OF 250 POUNDS PER SQUARE INCH (psi).
- DURING EXCAVATION, IF SUITABLE INDIGENOUS SOIL SUBGRADES ARE ENCOUNTERED AT A SHALLOWER DEPTH AND APPROVED BY A QUALIFIED GEOTECHNICAL ENGINEER, THE FOUNDATION MAY BEAR DIRECTLY ON THE SUITABLE INDIGENOUS SOILS. ACCORDINGLY, CLOSE FULL-TIME INSPECTION OF THE SUBGRADE EXCAVATION IS STRONGLY RECOMMENDED.
- 5. SEE TYPICAL STRUCTURAL FILL PLACEMENT DETAIL ON S501.



GENERATOR PLATFORM PLAN

SCALE: 1/2" = 1'-0"


GENERATOR PAD PLAN NOTES:

- 1. COORDINATE PAD SIZE AND LAYOUT OF PLATFORM WITH APPROVED GENERATOR.
- ALL STEEL MEMBERS, COMPONENTS, AND FASTENERS THIS SHEET SHALL BE HOT-DIPPED
- GALVANIZED. PAD TO BE 5,000 PSI CONCRETE.
- GALVANIZED STAIRS SHALL HAVE 12" DEEP TREADS EVENLY SPACED (MAXIMUM RISE 7").

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REVISIONS

FOUNDATION ENERATOR



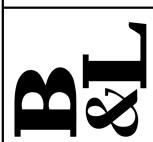

NYS EXP. 05/31/202

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AS SHOWN


Sheet Number S101

Project Number

1 BUILDING SECTION
STORY SCALE: 1/4" = 1'-0"

TOP OF PLANK 644.67' VERTICAL CONTROL JOINT (C.J.) TOP OF CONC. SLAB
633.33'
TOP OF EXIST. FLOOR
632.0' TOP OF CONC. FTG 628.67' RE: FOUNDATION WALL STEPPED FOOTING DETAIL TOP OF LOWER CONC. FTG 618.00' DOWEL INTO EXISTING FOOTING W/ (3) #4 x 2'-6" REINF. BAR. EMBED REBAR 6" INTO EXIST. FOOTING WITH 3/4"Ø DRILLED NOTE: CONCRETE REINFORCING NOT SHOWN FOR CLARITY

2 BUILDING SECTION
SCALE: 1/4" = 1'-0"

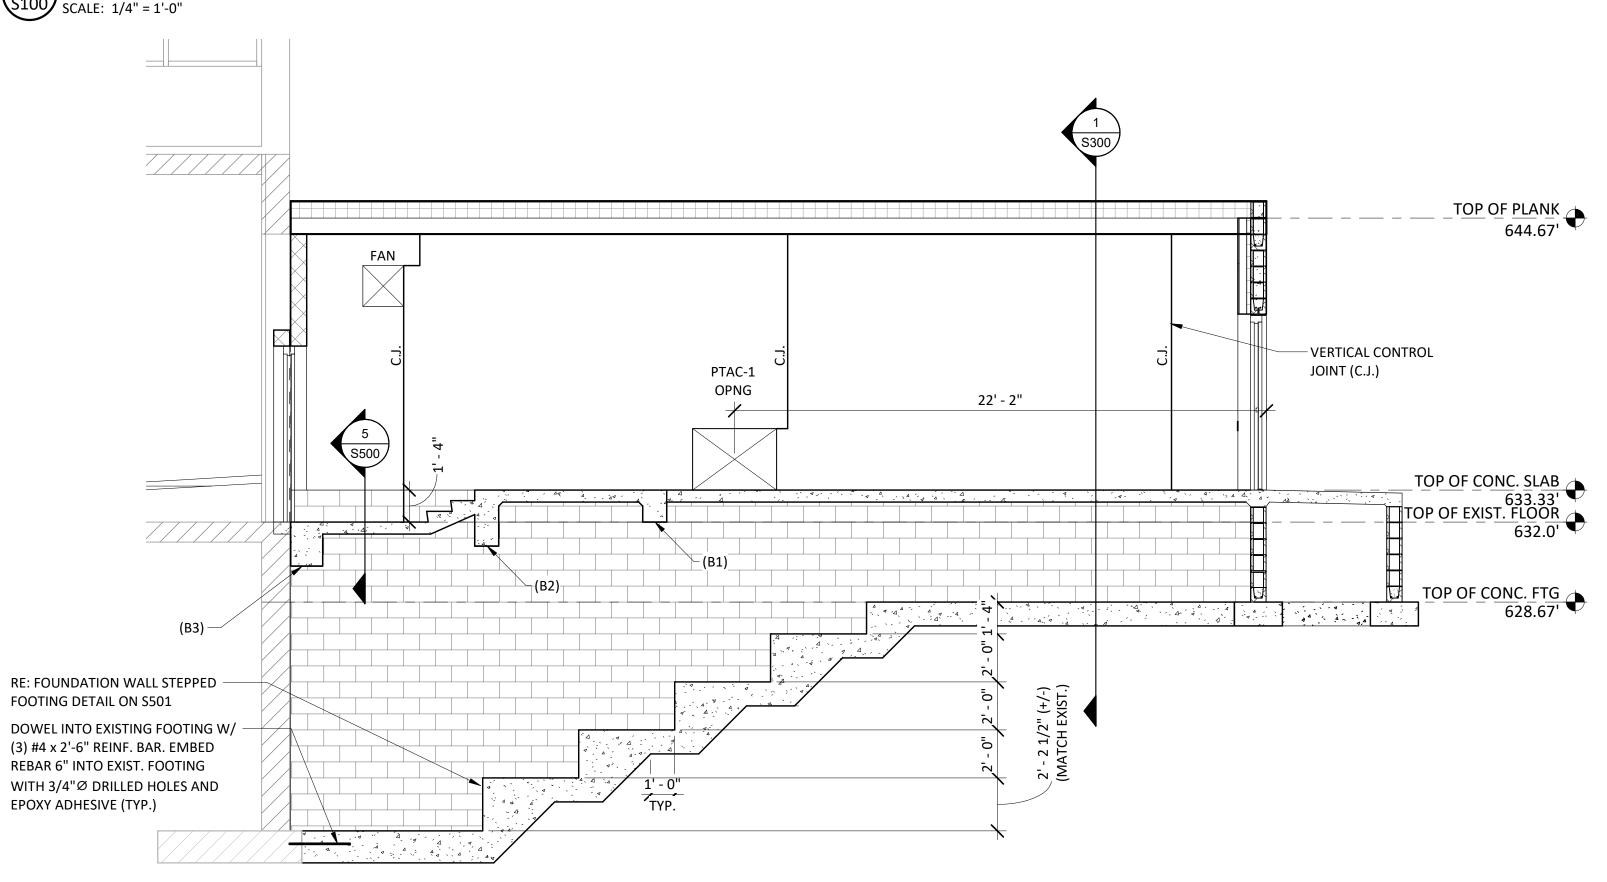

NOTE: CONCRETE REINFORCING NOT SHOWN FOR CLARITY

3 BUILDING SECTION
STORY SCALE: 1/4" = 1'-0"

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IT IS A VIOLATION OF THE NEW YORK STATE

REVISIONS

SECTIONS BUILDING STRUCTURAL

CAYUGA LAKE INTERMUNICIPAL WATER COMMISSION WATER TREATMENT FACILITY ELECTRICAL UPGRA

HOLES AND EPOXY ADHESIVE (TYP.)




OCTOBER, 2023

AS SHOWN

Sheet Number S300

PROVIDE TEMPORARY SHORING OF EXISTING FOUNDATION AND EARTH BELOW EXISTING FOUNDATION AND FLOOR SLAB TO CONSTRUCT THE ADDITION FOUNDATION.

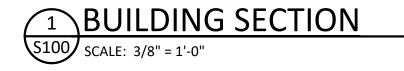


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REVISIONS

SECTIONS

SOUTHERN CAYUGA LAKE INTERMUNICIPAL WATER COMMISSION TON POINT WATER TREATMENT FACILITY ELECTRICAL UPGRADES

STRUCTURAL

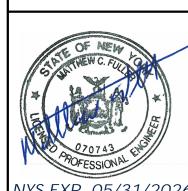


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S301



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REVISIONS

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SOUTHERN CAYUGA LAKE INTERMUNICIPAL WATER COMMISSION
ON POINT WATER TREATMENT FACILITY ELECTRICAL UPGR
FOUNDATION SECTIONS

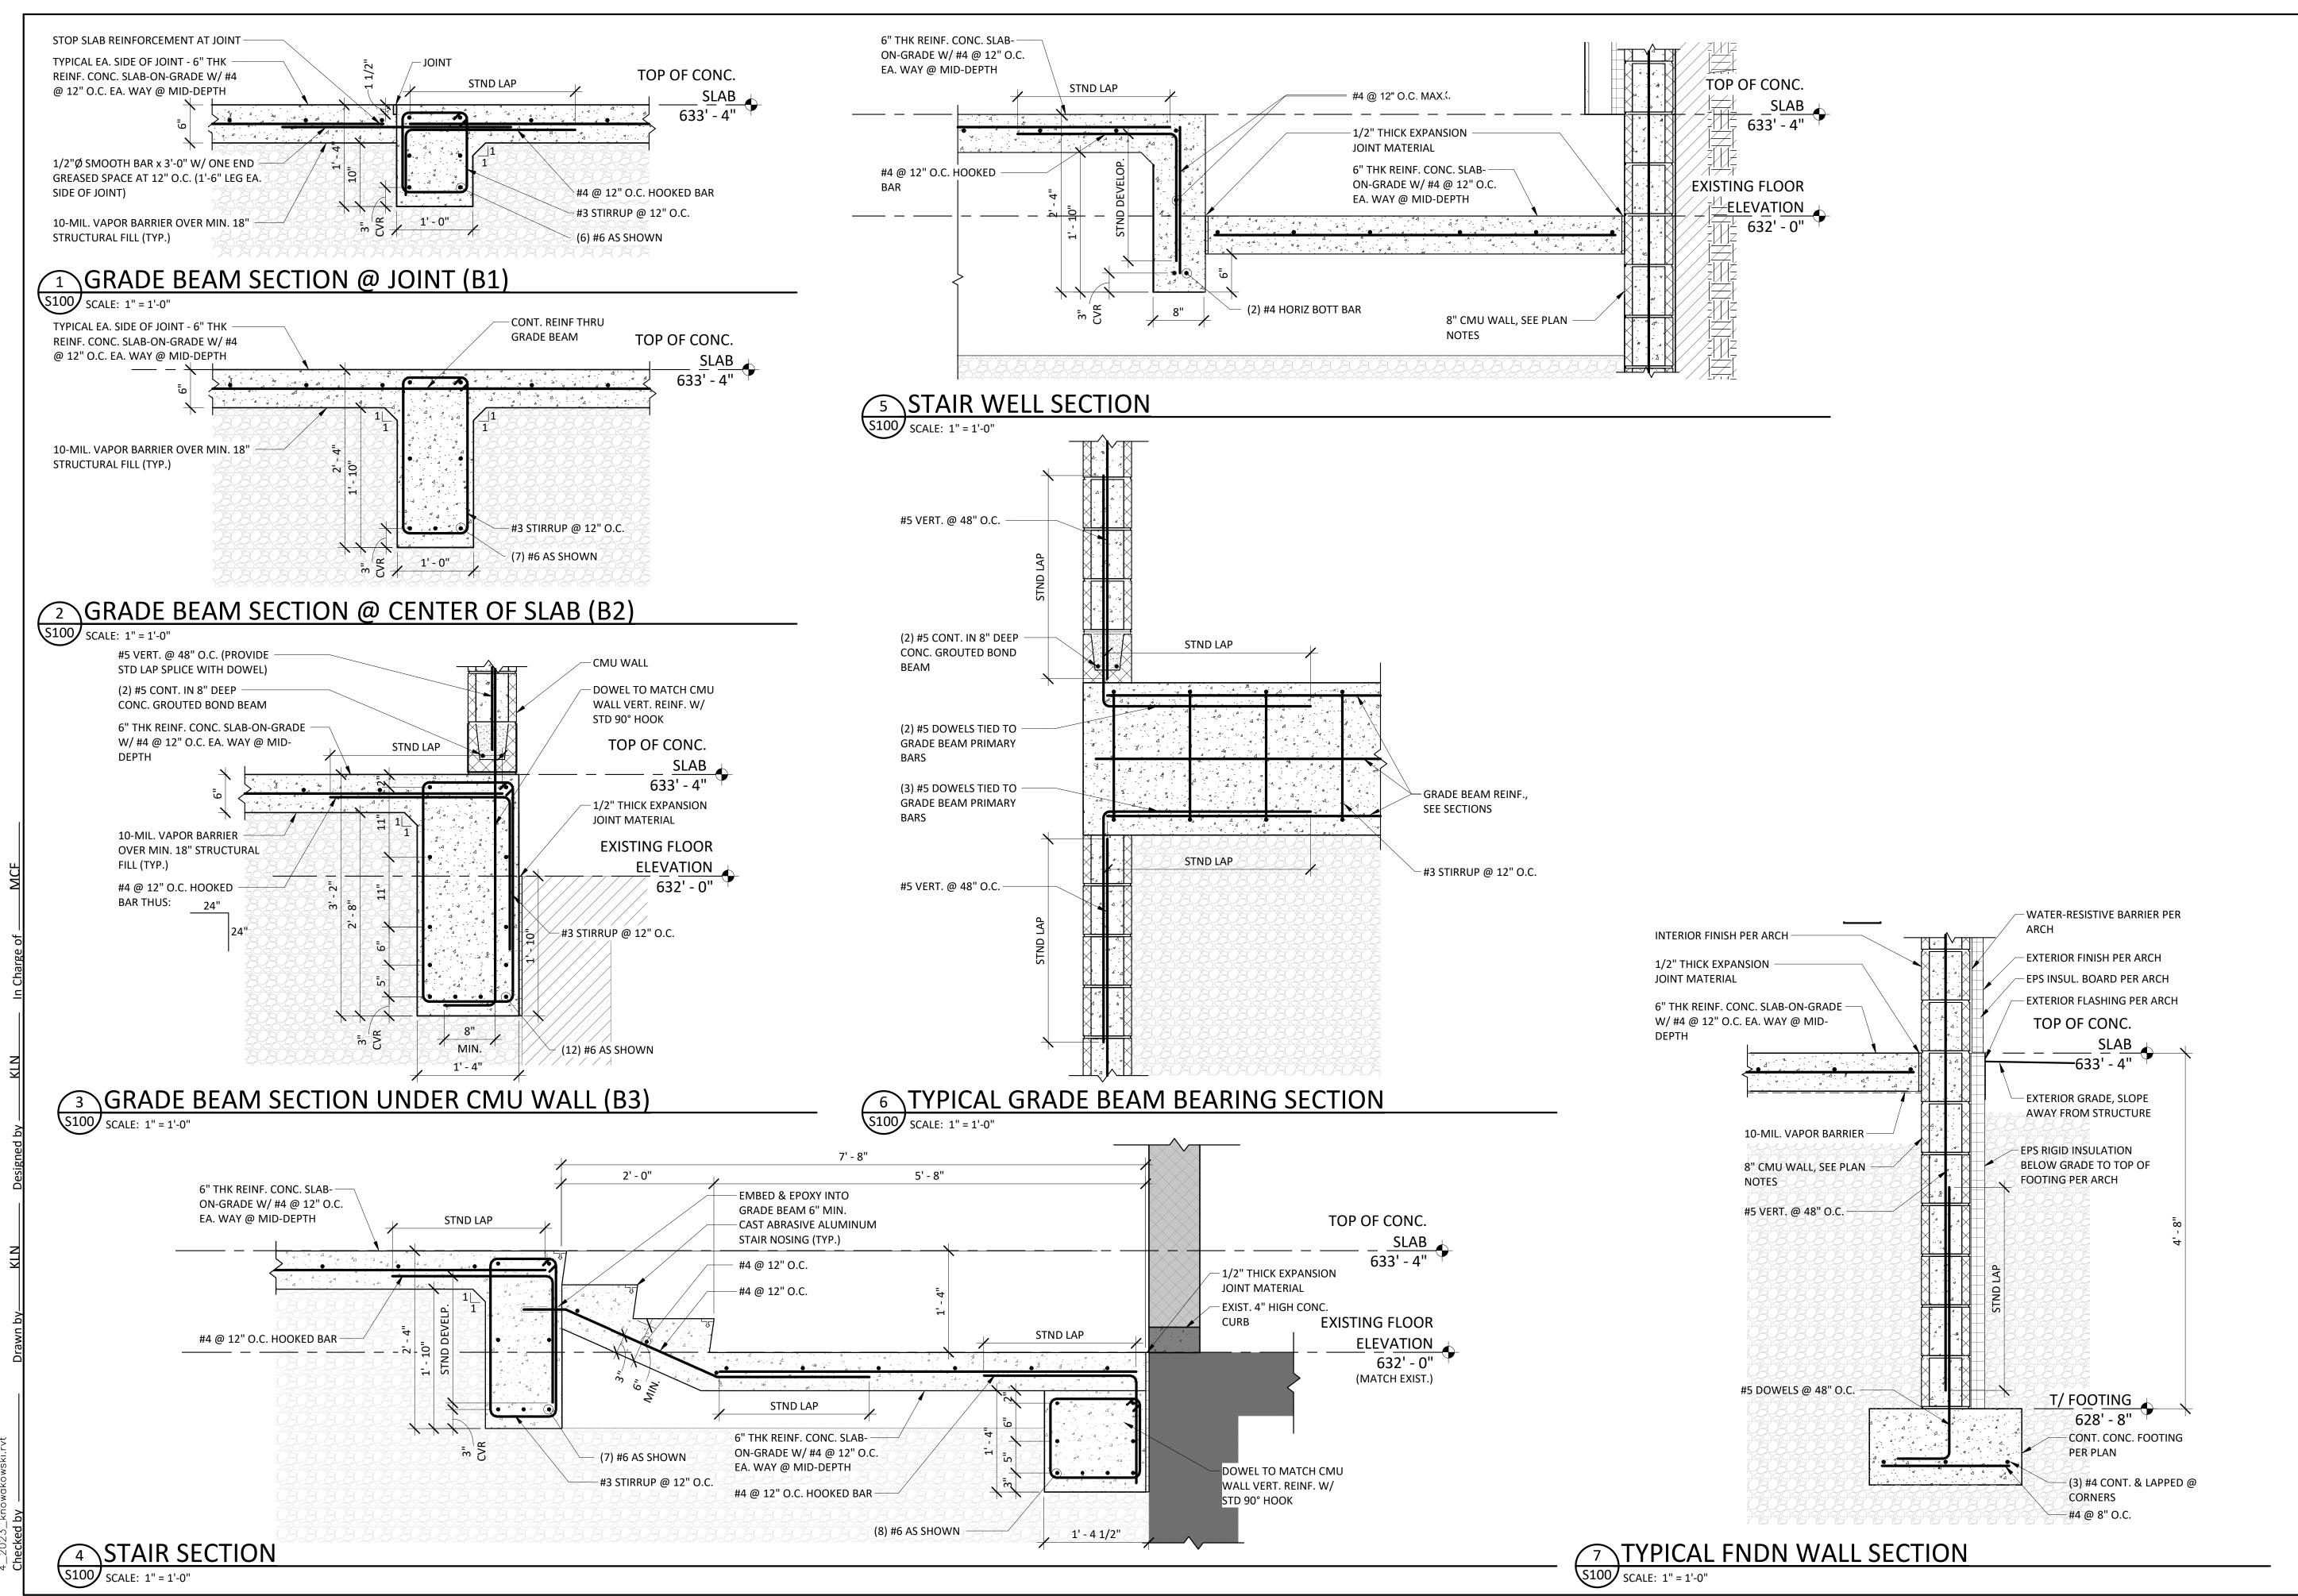irpool, NY 38

Liverpool, NY 13088



NYS EXP. 05/31/2026
Date

OCTOBER, 2023

AS SHOWN

Sheet Number S500

CONCRETE FOUNDATION OPTIONAL PLACEMENT (MIN) OF COMPACTED STRUCTURAL FILL COMPACTED STRUCTURAL FILI - APPROVED SUBGRADE

- STRUCTURAL FILL AT A MINIMUM DEPTH OF 7.5 FEET BELOW EXISTING GRADE. STRUCTURAL FILL SHALL BE PLACED BEYOND FOUNDATION LIMITS A HORIZONTAL DISTANCE EQUAL TO AT LEAST 0.5 TIMES THE DEPTH OF THE STRUCTURAL FILL LAYER
- BENEATH THE FOUNDATION BUT NO LESS THAN 12 INCHES. EXTENTS AND PROJECTION (SLOPE) OF STRUCTURAL FILL SHOWN ARE OF MINIMUM **REQUIREMENTS**
- DURING EXCAVATION, IF SUITABLE INDIGENOUS SOIL SUBGRADES ARE ENCOUNTERED AT A SHALLOWER DEPTH AND APPROVED BY A QUALIFIED GEOTECHNICAL ENGINEER, THE FOUNDATION MAY BEAR DIRECTLY ON THE SUITABLE INDIGENOUS SOILS.

SEE PLAN - CONTINUOUS STRIP FOOTING MASONRY EXTEND REBAR TO EDGE OF WALL STEP W/ STD. HOOK - "Z" BARS TO MATCH BOT FOOTING REINF REINF AS SHOWN WITH TYP SEE PLAN/DETAILS LAP AT EACH END


SEE FOUNDATION PLAN FOR TOP OF FOOTING ELEVATION. FOOTING STEP REINFORCEMENT TO MATCH WALL AND / OR

FOUNDATION STEP


- FOOTING REINFORCEMENT SIZE AND SPACING.
- TRANSVERSE REINF. NOT SHOWN FOR CLARITY.
- SUBBASE NOT SHOWN. REFER TO SOILS REPORT.

FOUNDATION WALL STEPPED FOOTING

SCALE: 3/4" = 1'-0"

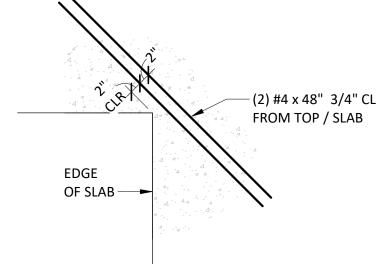


SCALE: 3/4" = 1'-0"

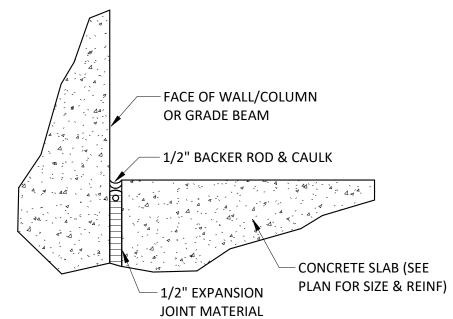

EXPANSION JOINT DETAIL

ADD. REINF. AT S.O.G. CORNERS

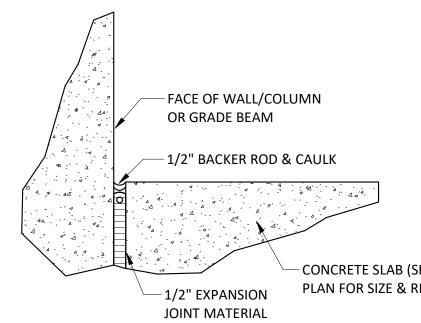


UNSUITABLE INDIGENOUS SOIL SUBGRADE SHALL BE REMOVED AND REPLACED WITH

TYPICAL STRUCTURAL FILL PLACEMENT

SCALE: 3/4" = 1'-0"

INSTALL SAW CUT PER TYPICAL -ACI REQUIREMENTS SEE PLAN FOR SPACING REQUIREMENTS - CONTINUE 50% SLAB 1/4" MIN REINFORCEMENT THROUGH JOINT ✓ SAWCUT CONCRETE SLAB, SEE PLAN FOR SIZE & REINFORCEMENT **SAWED CONTROL JOINT (SJ)**

1 EXTERIOR SLAB SECTION

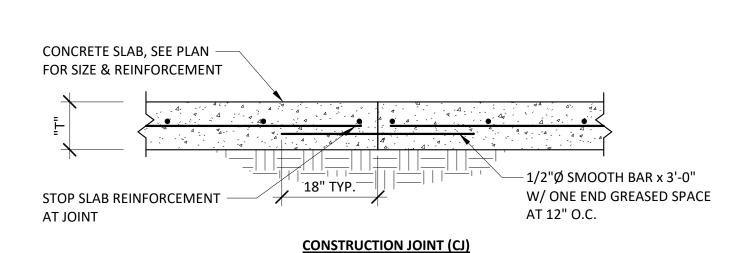

SLAB-ON-GRADE CONTROL JOINTS SCALE: NOT TO SCALE

- REFER TO PLANS AND SECTIONS FOR REBAR 632' - 0" T = 6" 10-MIL VAPOR BARRIER (INTERIOR SPACE) - COMPACTED STRUCTURAL FILL

> **TYPICAL SLAB ON GRADE** SCALE: 1" = 1'-0"

TYP. REINF. AROUND CONC. OPENING DETAIL

SCALE: 3/4" = 1'-0"

- 2-#6 @ 6 X (D=4') LG. E.F.

DIAGONALLY

- 2" CLEAR. (TYP)

-EXTRA BARS E.F. (SEE NOTE) TYP.

ON EACH SIDE OF OPENING PROVED EXTRA BARS EQUIVALENT IN AREA TO 1/2

EXTEND BARS A MIN. OF 48 BAR DIAMETERS BEYOND THE FACE OF THE OPENING.

THE AREA OF BARS CUT BY THE OPENING. MIN. BAR SIZE SHALL BE #5.

DETAIL ALSO APPLIES TO DOOR OPENINGS IN CONCRETE WALLS.

SCALE: NOT TO SCALE

Sheet Number S501

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REVISIONS

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OUNDATION

SOUTHERN CAYUGA LAKE INTERMUNICIPAL WATER COMMISSION TON POINT WATER TREATMENT FACILITY ELECTRICAL UPGR

ROOF SYSTEM PER ARCH-_T<u>/</u> PLANK 644' - 8" FORM AS REQ'D #4 BENT BAR GROUTED INTO — (1) #5 CONT. KEYWAY/VOID @ 48" O.C. THUS: 24" 8" PRECAST CONCRETE HOLLOW CORE PLANK ROOFING SYSTEM PER PLAN 4" BRG W/ 1/8" THK -KOROLATH BEARING PAD (2) #5 CONT. IN 8" DEEP -CONC. GROUTED BOND 8" CMU WALL W/ #5 @ 48" O VERT. REINF. (SEE PLAN NOTES INTERIOR FINISH PER ARCH


CONTROL JOINT KEY — ADDITIONAL VERTICAL HORIZONTAL JOINT -AS SPECIFIED FULL REINFORCEMENT TO WALL REINFORCEMENT **HEIGHT OF WALL** STOP AT CONTROL (TO MATCH TYP WALL **BUTTER FACE SHELL** REINFORCEMENT) RAKE AT CONTROL JOINT ONLY — CONTROL JOINT KEY CONTROL JOINT - SEALANT - EXTERIOR FACE OF WALL - EXTERIOR FACE

TYPICAL VERTICAL CMU CONTROL JOINT


SCALE: NOT TO SCALE

ROOF SYSTEM PER ARCH-

→ SLOPE PER ARCH

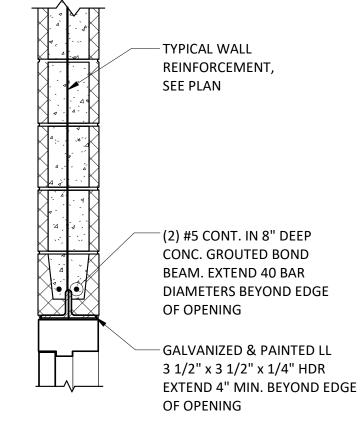

TYP CMU OPENING W/ STEEL LINTEL & BOND BEAM DETAIL

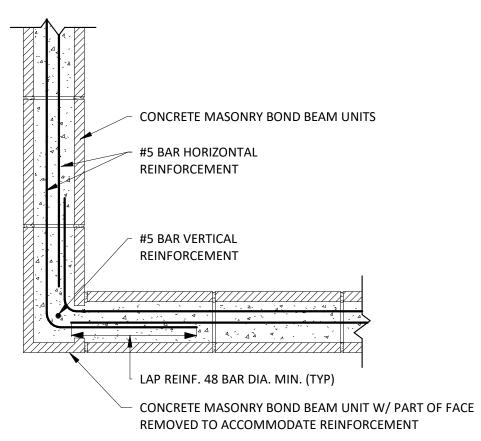

TYP. BOND BEAM CORNER REINF.

SCALE: 1" = 1'-0"

FOLLOWED BY THEIR SIGNATURE, THE DATE OF SUCH ALTERATION, AND A SPECIFIC DESCRIPTION OF THE ALTERATION **REVISIONS**

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INCLUDE THE NOTATION "ALTERED BY

DETAIL AND

SECTIONS SOUTHERN CAYUGA LAKE INTERMUNICIPAL BOLTON POINT WATER TREATMENT FACILITY **FRAMING** ROOF

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OCTOBER, 2023


AS SHOWN

Sheet Number S502

Project Number 677.006.001

SCALE: 1" = 1'-0"

8" HOLLOW CORE PLANK AT PARALLEL CMU WALL
S100 SCALE: 1 1/2" = 1'-0"

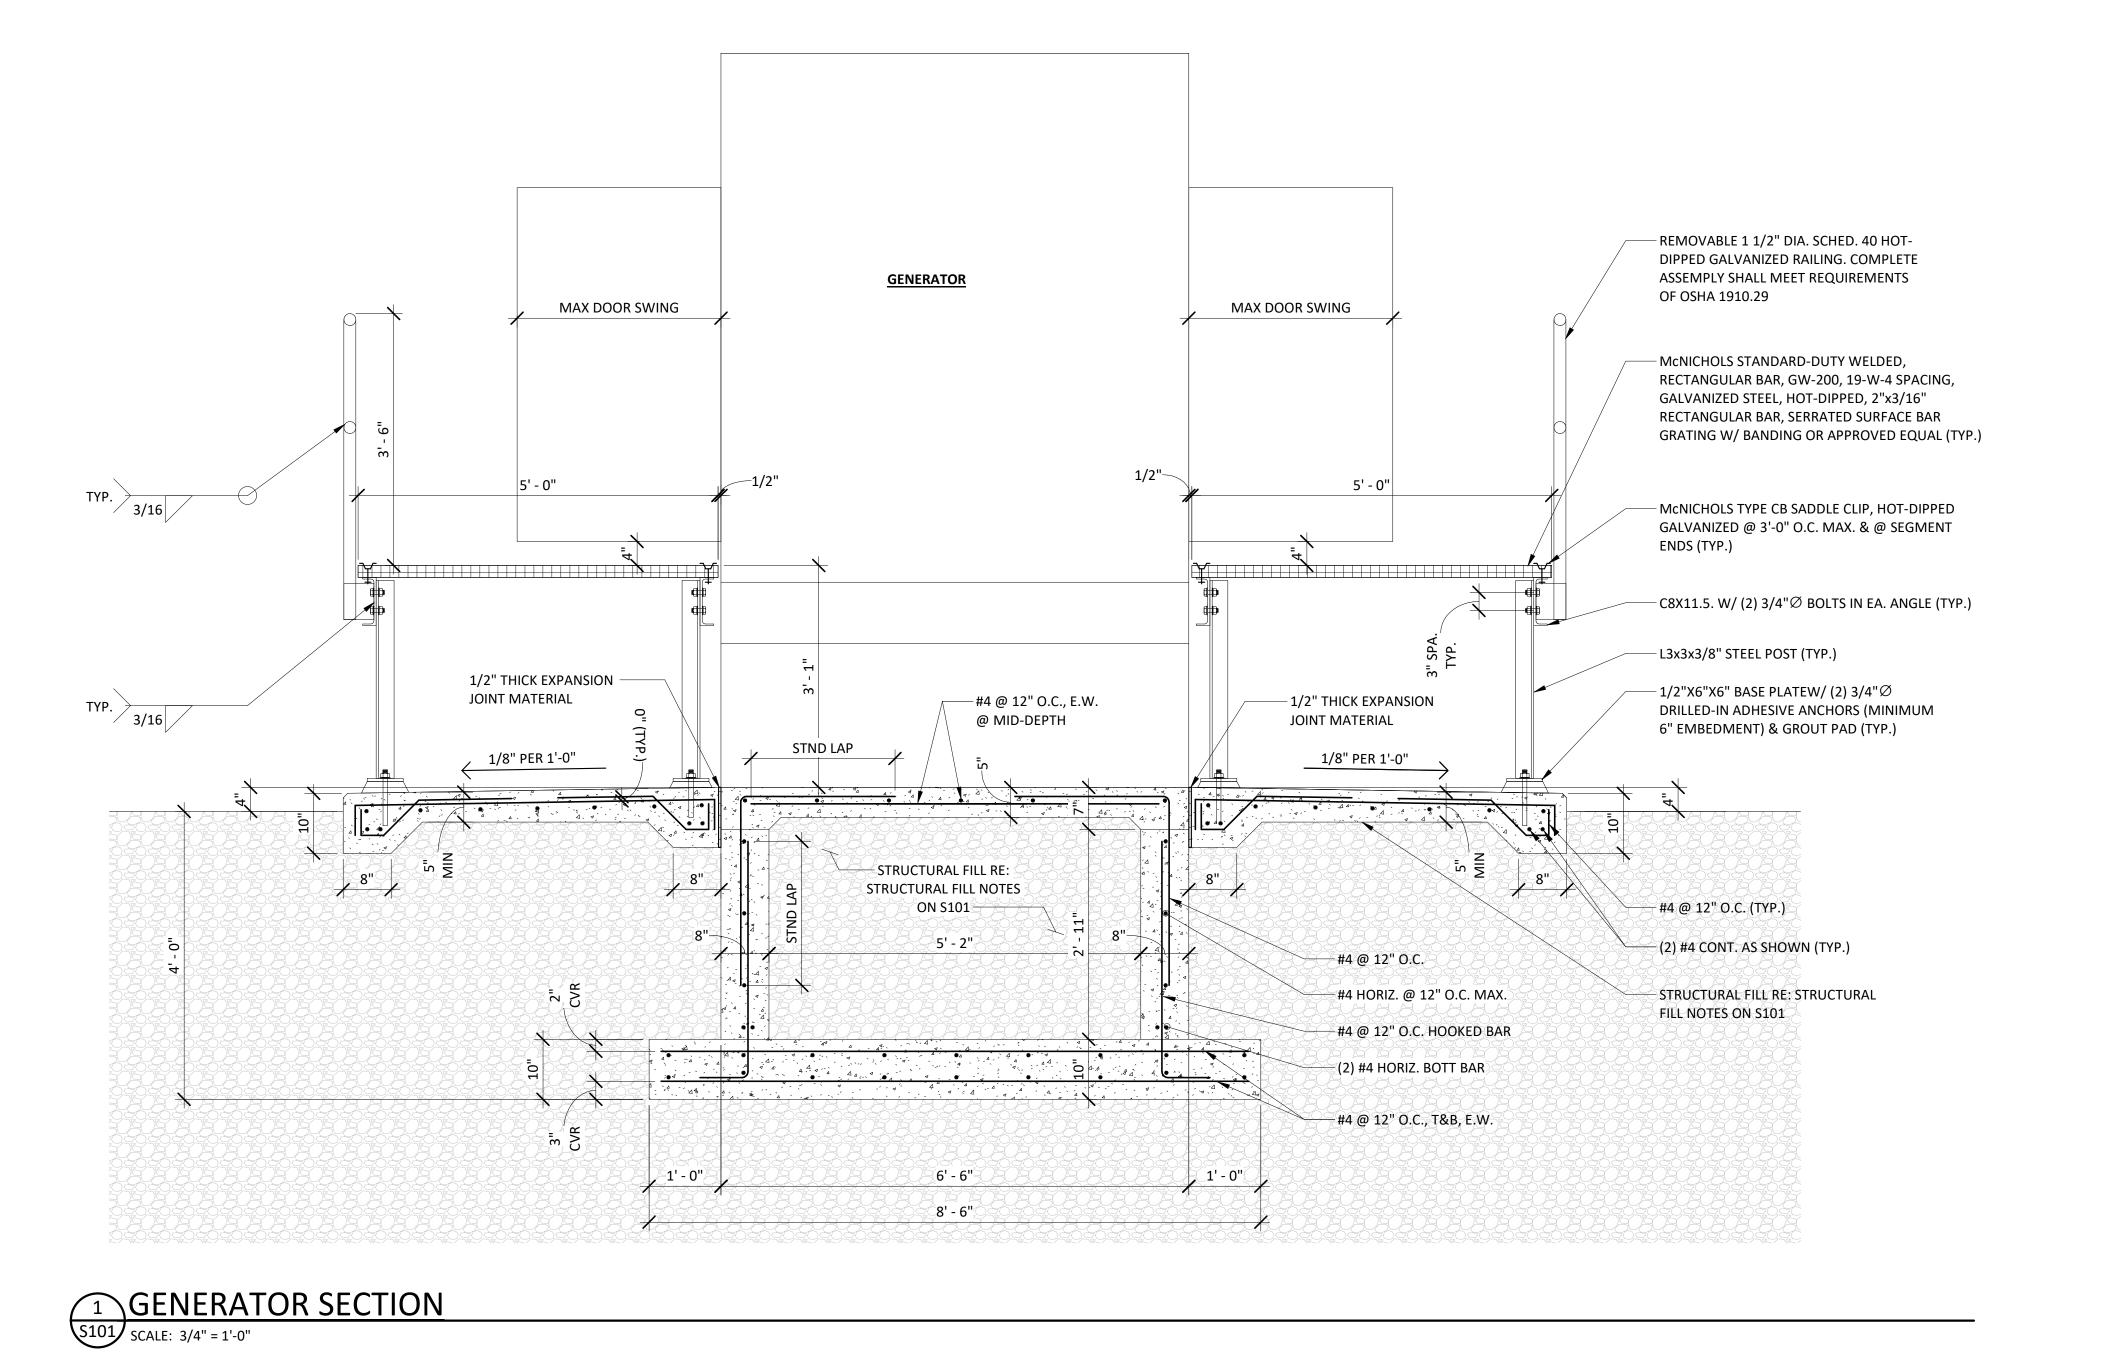


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SECTION ENERATOR

SOUTHERN CAYUGA LAKE INTERMUNICIPAL WATER COMMISSION TON POINT WATER TREATMENT FACILITY ELECTRICAL UPGR




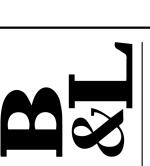

OCTOBER, 2023

AS SHOWN

Sheet Number S503

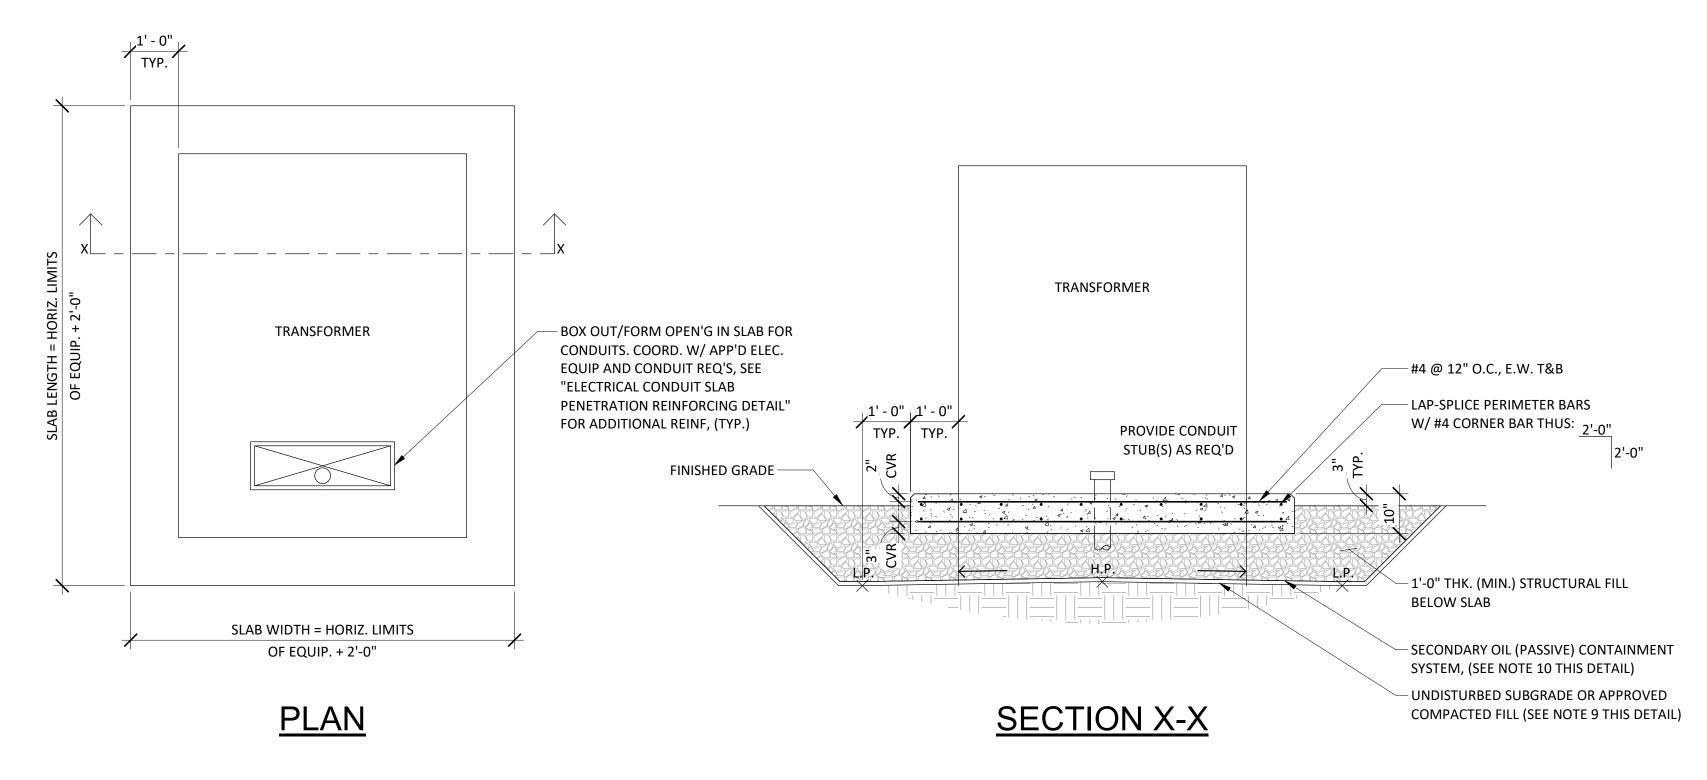

- 1. SLAB SHALL BE 10" THICK, USING A 28 DAY DESIGN CONCRETE MIX OF 4,000 PSI W/ 6% (+/- 1%) AIR ENTRAINMENT.
- REINFORCEMENT SHALL COMPLY W/ ASTM A-615, GRADE 60 (DEFORMED).
- TOP OF PAD SHALL HAVE A SMOOTH TROWELED FINISHED.
- PROVIDE 3/4" CHAMFER @ ALL EXPOSED EDGES (INCLUDING OPENING).
- TYPICAL SLAB REINFORCING SHALL BE #4 @ 12" O.C. EACH WAY, TOP AND BOTTOM.
- CONCRETE COVER OVER REINFORCEMENT SHALL BE 2" CLEAR AT TOP AND SIDES OF PAD, 3" CLEAR AT BOTT. OF PAD.
- STRUCTURAL FILL SHALL BE FLOWABLE BACKFILL MATERIAL WITH NON-SWELLING CEMENT / FINE AGGREGATE TYPE MATERIAL AND SHOULD HAVE A MINIMUM 28-DAY COMPRESSIVE STRENGTH (f'c) OF 250 POUNDS PER SQUARE INCH
- PROVIDE MANUFACTURED, PRE-FABRICATED PLASTIC CHAIR SUPPORT OF SLAB REINFORCEMENT SPACED TO MAINTAIN REINFORCEMENT LOCATION AS SHOWN. REINFORCEMENT SUPPORTS SHALL BE SPACED AS NEEDED TO PREVENT MOVEMENT DUE TO WEIGHT OF CONSTRUCTION MATERIALS, EQUIPMENT AND WORKERS. REINFORCEMENT SUPPORTS SHALL BE AS MANUFACTURED BY DAYTON SUPERIOR, TYPE: AZTEC "CASTLE CHAIR – PCC" AND "STRONGBACK SBU SLAB BOLSTER UPPER – PSBU", OR APPROVED EQUAL.
- 9. SLOPE SUB-GRADE 0.5% (MIN.) IN EACH DIRECTION FROM A HIGH POINT (H.P.) AT SLAB CENTER TO LOW POINT (L.P.) AT 1'-0" BEYOND SLAB LIMITS.
- 10. PROVIDE SECONDARY OIL (PASSIVE) CONTAINMENT SYSTEM (SOCS), TYPE: SORBWEB PLUS AS MFGR'D. BY ALBARRIE GEOCOMPOSITES LTD (www.sorbwebplus.com). SOCS SHALL BE A NEEDLE-PUNCHED NON-WOVEN GEOTEXTILE MAT INFUSED WITH OIL IMMOBILIZER TO ALLOW SURFACE/GROUND WATER TO PASS, BUT SHALL SEAL AND BLOCK FLOW UPON CONTACT WITH OIL. SYSTEM SHALL BE DESIGNED AND INSTALLED TO COMPLY WITH SPCC, 40 CFR 112.(7)(C) SECONDARY CONTAINMENT FOR ELECTRICAL EQUIPMENT AND IEEE P980 GUIDE FOR CONTAINMENT AND CONTROL OF OIL SPILLS IN ELECTRICAL SUBSTATIONS. DOCUMENTATION OF SYSTEM'S COMPLIANCE WITH THE CITED SPCC AND IEEE REQUIREMENTS SHALL BE SUBMITTED FOR REVIEW AND ACCEPTANCE BY THE ENGINEER PRIOR TO SYSTEM PURCHASE AND INSTALLATION.
- 11. ANCHORAGE OF EQUIPMENT TO SLAB BY EQUIPMENT MFGR. (TYP.).

TRANSFORMER PAD

SCALE: 1/2" = 1'-0"


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REVISIONS

TRANSFORMER

SOUTHERN CAYUGA LAKE INTERMUNICIPAL WATER COMMISSION ON POINT WATER TREATMENT FACILITY ELECTRICAL UPGR



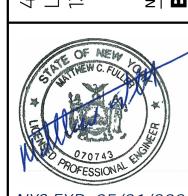

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Sheet Number S504

Project Number

OPERATIONAL BE INSTALLED.

CONTRACTOR SHALL FIELD VERIFY ALL LOCATIONS, DIMENSIONS AND ELEVATIONS BEFORE DEMOLITION AND CONSTRUCTION.

ALL MATERIALS, EQUIPMENT, METHODS OF INSTALLATION, REMOVALS AND DISPOSAL SHALL BE IN ACCORDANCE WITH THE STANDARDS, REGULATIONS, CODES, ORDINANCES, AND LAWS OF AUTHORITIES THAT HAVE LAWFUL JURISDICTION.

COMPLETELY COORDINATE WORK OF THIS TRADE WITH WORK OF OTHER TRADES AND OWNERS WORK.

WORK SHALL BE EXECUTED IN A WORKMANLIKE MANNER AND SHALL PRESENT NEAT, RECTILINEAR APPEARANCE WHEN COMPLETED. MAINTAIN MAXIMUM HEAD ROOM AT ALL TIMES.

MATERIALS AND EQUIPMENT SHALL BE NEW AND INSTALLED ACCORDING TO MANUFACTURER'S INSTRUCTIONS AND RECOMMENDATIONS. MAINTAIN MANUFACTURER'S EQUIPMENT CLEARANCES.

DO NOT SUPPORT EQUIPMENT FROM SUSPENDED CEILINGS. ALL SUPPORT SHALL COME FROM BUILDING STRUCTURE. SUPPORTS SHALL BE SELECTED AND INSTALLED TO PROVIDE A VIBRATION FREE INSTALLATION.

PROVIDE PROPER ACCESS TO MATERIALS AND EQUIPMENT THAT REQUIRE INSPECTION, REPLACEMENT, REPAIR OR SERVICE SUCH AS COILS, DAMPERS, HEATERS, VALVES, ETC. IF PROPER ACCESS CANNOT BE PROVIDED, CONFER WITH THE ENGINEER AS TO THE BEST METHOD OF APPROACH TO MINIMIZE THE EFFECT OF THE REDUCED ACCESS WHICH MAY RESULT.

NOTES, SYMBOLS LIST AND DETAILS ARE APPLICABLE TO ALL DRAWINGS FOR THIS TRADE.

ALL WORK SHOWN IS TO BE COMPLETED BY THIS TRADE UNLESS SPECIFICALLY INDICATED OTHERWISE.

11. CONTRACTOR IS RESPONSIBLE FOR ALL OWNER COORDINATION AND PROCEDURES RELATED TO SHUTTING DOWN AND RESTARTING SYSTEMS, INCLUDING THOSE REQUIRED FOR RELOCATIONS, TO ALLOW FOR COMPLETION OF ALL DEMOLITION AND NEW WORK. INTERRUPTIONS TO EXISTING SERVICES AND SYSTEMS SHALL BE AS SHORT AS POSSIBLE AND AT A TIME AND DURATION APPROVED BY THE OWNER. INCLUDE ALL PREMIUM TIME ASSOCIATED WITH INTERRUPTIONS. ALL SYSTEM INTERRUPTIONS SHALL BE SCHEDULED WITH OWNER AND COORDINATED WITH OTHER TRADES.

∠ - ANGLE AAD - AUTOMATIC AIR DAMPER ACT - ACOUSTICAL CEILING TILE AFG - ABOVE FINISHED GRADE ALUM - ALUMINUM BLDG - BUILDING BSMT - BASEMENT BOT - BOTTOM

ABBREVIATIONS:

CLG - CEILING

COL - COLUMN

CPT - CARPET

DN - DOWN

DTL - DETAIL

EA - EACH

CONC - CONCRETE

CT - CERAMIC TILE

DS - DOWNSPOUT

DWG - DRAWING

E.F. - EACH FACE

E.W. - EACH WAY

ELEC - ELECTRICAL

ELEV - ELEVATION

EMBED - EMBEDMENT

EQUIP - EQUIPMENT

EW - EACH WAY

EXP - EXPOSED

EXT - EXTERIOR

FTG - FOOTING

GA - GAUGE

EX, EXIST - EXISTING

FIN FLR - FINISHED FLOOR

FLA - FULL LOAD AMPS

FPM - FEET PER MINUTE

GC - GENERAL CONTRACTOR

POWER VENT WITH DISCONNECT SWITCH

- ALUMINUM CURB CAP

BACKDRAFT DAMPER

MECHANICAL CONTRACTOR

PRE-FAB CURB BY

FND - FOUNDATION

GALV - GALVANIZED

HBD - HARDBOARD

HC - HANDICAP

EC - ELECTRICAL CONTRACTOR

EPS - EXPANDED POLYSTYRENE

CONST - CONSTRUCTION

CONT - CONTINUOUS

CLR - CLEAR

BUR - BUILT UP ROOF CB - CATCH BASIN C/C - CENTER TO CENTER CFM - CUBIC FEET PER MINUTE CJ - CONTROL JOINT CL - CENTER LINE

MAS - MASONRY MAX - MAXIMUM MC - MECHANICAL CONTRACTOR MIN - MINIMUM MR - MOISTURE RESISTANT MTL - METAL

MO - MASONRY OPENING NAT - NATURAL NIC - NOT IN CONTRACT NTS - NOT TO SCALE O/C - ON CENTER OD - OUTSIDE DIAMETER PL - PLATE PERF - PERFORATED DEMO - DEMOLISH, DEMOLITION PLAS - PLASTIC PLYWD - PLYWOOD

ABBREVIATIONS (CONT.)

HM - HOLLOW METAL

HP - HORSE POWER

INSUL - INSULATION

IGU - INSULATED GLASS UNIT

MANUF - MANUFACTURER

HZ - HERTZ

INV - INVERT

LAM - LAMINATE

JT - JOINT

PNT - PAINT PT - PRESSURE TREATED **PVMT - PAVEMENT** QT - QUARRY TILE R - RISER RD - ROOF DRAIN RAD - RADIUS

REQ'D - REQUIRED RO - ROUGH OPENING SC - SOLID CORE SAN - SANITARY SHT - SHEET SIM - SIMILAR

E.S.P - EXTERNAL STATIC PRESSURE SQ - SQUARE S.S. - STAINLESS STEEL STL - STEEL SUS - SUSPENDED SV - SHEET VINYL

T - TREAD T/ - TOP OF T&B - TOP AND BOTTOM TEMP - TEMPERED TYP - TYPICAL

VCT - VINYL COMPOSITION TILE VIF - VERIFY IN FIELD W.G - WATER GAUGE

SEAL WEATHER

CONDENSATE DRAIN-

REAR GRILLE -

EXTERNAL

TIGHT ALL AROUND -

→ BREAK

-S- SLOPE DN IN DIRECTION OF ARROW

******** PIPING/EQUIPMENT TO BE REMOVED

LIMIT OF REMOVAL

CONNECTION POINT TO EXISTING —○— TEE RISE

<u>LEGEND</u>

○ PIPE RISE C-PIPE DROP

→ DIRECTION OF FLOW

CAP

= UNION

CONCENTRIC REDUCER

——|— FLANGED CONNECTION FLEXIBLE CONNECTION

BUTTERFLY VALVE

PRESSURE GAUGE **THERMOMETER**

MANUAL AIR VENT **AUTOMATIC AIR VENT**

SWING CHECK VALVE

STRAINER

BALL VALVE

GATE VALVE

GLOBE VALVE

TRIPLE DUTY VALVE

BALANCE VALVE \otimes

BALL VALVE W/ HOSE CONNECTION, CAP AND CHAIN

PRESSURE REDUCING VALVE

SAFETY RELIEF VALVE TEMPERATURE SENSOR

PUMP

WALL SLEEVE

PTAC INSTALLATION DETAIL

NOT TO SCALE

CONTROL VALVE, 3-WAY, MODULATING

EXTERIOR WALL WITH

SHEETS FOR ADDITIONAL

- LEVELING SUPPORT LEG

WITH ADJUSTABLE BASE

INFORMATION

−<u>PTAC-1</u>

- SUPPLY AIR GRILLE

INSULATION. SEE ARCHITECTURAL

LEGEND (CONT.):

── VOLUME DAMPER

→ FIRE DAMPER

SUPPLY DUCT SECTION UP SUPPLY DUCT SECTION DOWN

RET/EXH DUT SECTION UP

RET/EXH DUT SECTION DOWN

45° BRANCH DUCT CONNECTION

NEW SUPPLY DIFFUSER, REGISTER OR GRILLE (WITH CFM)

NEW RETURN/EXHAUST REGISTER OR GRILLE (WITH CFM)

THERMOSTAT (ARROW INDICATES DEVICE)

PACKAGED TERMINAL AIR CONDITIONING UNIT (PTAC) SCHEDULE OUTDOOR FAN | ELECTRIC | TOTAL FAN FAN TYPE/ FAN FAN TYPE/ HEATING COOLING VOLTAGE DESIGN EQUIPMENT TAG AREA SERVED **AIRFLOW** (kW) (BTU/h) (CFM) DRIVE | # SPEEDS | DRIVE | # SPEEDS | PTAC-1 101 370 DIRECT DIRECT 14500 | 208 | AMANA HEC153H50WXXX | 65 2

NOTES:

1. PROVIDE UNIT WITH FACTORY MOUNTED AND WIRED DISCONNECT, FACTORY WALL SLEEVE, EXTERNAL DRAIN KIT AND ARCHITECTURAL LOUVER AND FRAME. 2. PROVIDE WITH HARD WIRED CONVERSION KIT

					EXHAUST	FAN SCH	IEDULE				
TAG	AREA SERVED	LOCATION	CFM	E.S.P.	DRIVE	RPM		MOTOF	?	DESIGN EQUIPMENT	NOTES
IAG	AREA SERVED	LOCATION	CFIVI	(IN W.G.)	DRIVE	KPIVI	HP	VOLTS	PHASE	DESIGN EQUIPIVIENT	NOTES
EF-4	EX. PUMP ROOM	ROOF	7970	.375	BELT	551	1-1/2	460	3	GREENHECK LB-30	1,2,3,4
EF-5	EX. PUMP ROOM	ROOF	7970	.375	BELT	551	1-1/2	460	3	GREENHECK LB-30	1,2,3,4
EF-6	ELECTRICAL ROOM ADDITION	WALL	550	.1	DIRECT	529	1/4	115	1	GREENHECK AER-20-03-0615-VG	1,2,3,5

1. PROVIDE BACKDRAFT DAMPER, ALUMINUM BIRD SCREEN

2. FAN SHALL BE UL LISTED AND AMCA CERTIFIED 3. PROVIDE MOTOR STARTER AND PREWIRED DISCONNECT.

4. INTERLOCK FANS WITH EXISITNG WALL SWITCHES AND EXISTING LOUVER.

5. PROVIDE WALL ON/OFF SWITCH AND INTERLOCK WITH IL-1.

		3.1 NOVIDE WALL ON OUT SWITCH	TAND IIV	TEREGOR V	/					ISSI UP
				INTAKE L	OUVER (IL)	SCHEDULE				· I 🗨 ·
TAG	LOCATION	DESCRIPTION		NOMIN	IAL SIZE	FREE AREA (FT ²)	FREE AREA VELOCITY (FPM)	ASSOCIATED EQUIPMENT		TER COMIN
				Н	W		VELOCITI (TTIVI)			WAT
IL-1	ELECTRICAL ROOM ADDITION	6-INCH ALUMINUM DRAINABLE	550	18"	24"	1.3	437	<u>EF-1</u>	GREENHECK EAD-635]

NOTES:

1. PROVIDE 1/2" ALUMINUM BIRD SCREEN.


2. UNIT SHALL BE OF CHANNEL FRAME CONSTRUCTION. COORDINATE MOUNTING WITH WALL TYPE.

3. UNIT SHALL BE AMCA CERTIFIED.

4. PROVIDE PHENOLIC EPOXY POWDER COATING (KYNAR) ON ENTIRE ASSEMBLY. COLOR BY OWNER.

5. COORDINATE SIZE WITH APPROVED LOUVER ASSEMBLY PRIOR TO CONSTRUCTION.

6. FURNISH AND INSTALL TWO-POSITION MOTORIZED DAMPER AND 120V ACTUATOR (BELIMO AF120, OR EQUAL), AND INTERLOCK WITH ASSOCIATED EQUIPMENT.

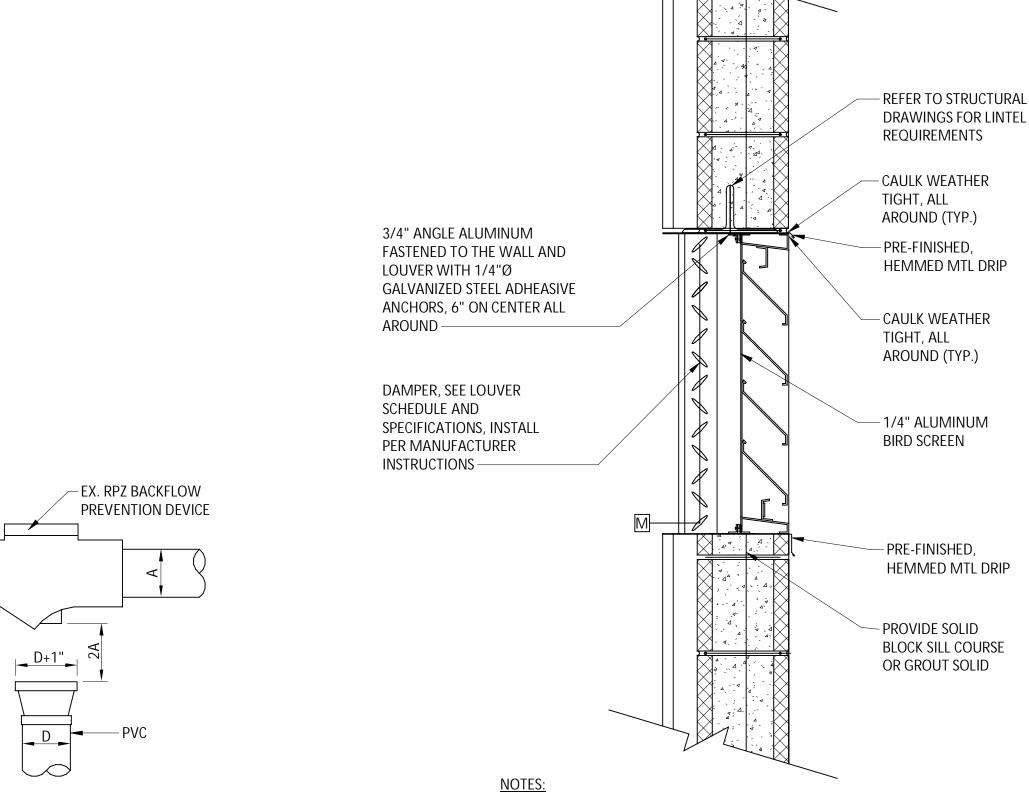

RPZ DISCHARGE DRAINAGE DETAIL

NOT TO SCALE

1. COORDINATE WALL OPENING LOCATIONS AND SIZES WITH ARCHITECTURAL DRAWINGS AND GC.

2. PROTECT METAL SURFACES FROM DIRECT CONTACT WITH CONCRETE OR MASONRY CONSTRUCTION WITH A COAT OF BITUMINOUS PAINT.

INTAKE LOUVER WITH MOD DETAIL

NOT TO SCALE

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REVISIONS

MOIL BBREVIA

 \triangleleft \triangleleft CAYUGA WATER BOI $\overline{\mathbb{Z}}$



EXP. 5-31-24 OCTOBER, 2023

AS SHOWN

Sheet Number M001

677.006.001

BIRD SCREEN

ALL AROUND

GASKET APPLIED

EXHAUST DUCTWORK

EXHAUST FAN DETAIL

NOT TO SCALE

TO UNDERSIDE

Project Number

MECHANICAL HVAC DEMOLITION PLAN SCALE: 1/8" = 1'-0"

LOUVER TO REMAIN - 40"x40" OPENING UP TO EF-5 LOCATED ON ROOF. REUSE EXISTING ROOF PENETRATION AND EX. 48"x48" METAL DRIP CURB PAN TO REMAIN. REMOVE AS NEEDED TO INSTALL NEW EXHAUST FAN AND - EX. 40"x40" OPENING UP REINSTALL -TO <u>EF-4</u> LOCATED ON RELOCATED FIRE ROOF. REUSE EXISTING ALARM WATER GONG ROOF PENETRATION AND ASSOCIATED AND CURB PIPING -- 8" RPZ DISCHARGE 7'-4" AFG TO

<u>EF-6</u> BOTTOM OF

<u>EF-6</u> TERMINATE 8" ALL ROOF DRAINS BY GC. SEE RPZ DISCHARGE WITH 45° ELBOW ROOM ADDITION ARCHITECHTURAL SHEETS FOR ADDITIONAL DOWN, S.S. RODENT SCREEN 101 INFORMATION (TYP. AND SPLASH 4"Ø DN FROM BLOCK — - 4"Ø DN FROM ROOF DRAIN-SECONDARY **ROOF DRAIN** MC TO CORE DRILL NEW PENETRATAION WITH WALL SLEEVE GROUTED 4"Ø PVC → IN PLACE. CAULK AND SEAL PIPE PENETRATION - CONNECTION TO ROOF DRAIN AND WEATHER TIGHT -ALL ASSOCIATED DRAIN PIPING BY MC 4"Ø DN FROM UNLESS OTHERWISE NOTED (TYP.) 4"Ø DN FROM SECONDARY **ROOF DRAIN** ROOF DRAIN-SECONDARY STORM DRAIN. TERMINATE AT 4'-0" AFG WITH S.S. RODENT SCREEN SEE C-101 FOR CONTINUATION 7'-4" AFG TO BOTTOM OF MECHANICAL ROOF PLAN MECHANICAL FLOOR PLAN


SCALE: 1/8" = 1'-0"

−EX. 96"x48" INTAKE

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REVISIONS

FIRST

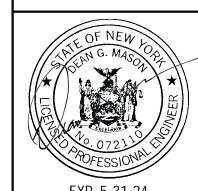

EXP. 5-31-24

OCTOBER, 2023

AS SHOWN

Sheet Number M101

Project Number 677.006.001

SCALE: 1/8" = 1'-0"

THEY MATCH THIS CONSTRUCTION DRAWING SET. THIS SHALL OCCUR PRIOR TO 1. THE CONTRACTOR SHALL OBTAIN ALL REQUIRED PERMITS AND ARRANGE FOR ALL REQUIRED INSPECTIONS IN ACCORDANCE WITH STATE AND LOCAL GOVERNING

2. ALL WORK SHALL BE DONE IN ACCORDANCE WITH NEC, AND STATE AND LOCAL

. UNLESS OTHERWISE INDICATED, PROVIDE A COMPLETE AND OPERATIONAL ELECTRICAL SYSTEM INCLUDING ALL NECESSARY MATERIAL, LABOR, AND EQUIPMENT. 2. ALL DISCONNECTS REQUIRED BY CODE MAY NOT BE SHOWN. CONTRACTOR SHALL

PROVIDE ALL NECESSARY DISCONNECTS AND OVERCURRENT PROTECTIVE DEVICES. 3. ALL EQUIPMENT AND MATERIAL SHALL BE LABELED AND LISTED. AND INSTALLED IN ACCORDANCE WITH THEIR LISTING.

4. PROVIDE ELECTRICAL POWER WIRING TO ALL MECHANICAL EQUIPMENT.

COORDINATION OF WORK I. THE CONTRACTOR SHALL COORDINATE AND VERIFY THAT WORKING AND DEDICATED EQUIPMENT SPACE REQUIREMENTS ARE MET PER NEC AND AHJ. 2. FIELD LOCATE ALL CORE DRILL LOCATIONS.

3. BEFORE CUTTING OR DRILLING INTO BUILDING ELEMENTS INSPECT AND LAYOUT WORK TO AVOID DAMAGING STRUCTURAL ELEMENTS AND BUILDING UTILITIES. 4. BEFORE SELECTING MATERIAL AND EQUIPMENT, AND PROCEEDING WITH WORK INSPECT AREAS WHERE MATERIAL AND EQUIPMENT ARE TO BE INSTALLED TO

ENSURE SUITABILITY, AND CHECK NEEDED SPACE FOR PLACEMENT, CLEARANCES AND INTERCONNECTIONS. 5. COORDINATION OF POSSIBLE SYSTEM SHUT-DOWNS AND WORK AREAS NEED TO BE COORDINATED WITH THE OWNER.

6. VERIFY RECEPTACLE, SWITCH, & COVER PLATE COLORS WITH OWNER 7. TURN OVER TO THE OWNER ALL MANUFACTURER'S WARRANTIES FOR EQUIPMENT AND MATERIALS PROVIDED.

1. THE DEFINITION OF ELECTRICAL TERMS USED SHALL BE AS DEFINED IN THE EDITION OF THE NATIONAL ELECTRIC CODE (NEC) AS REFERENCED IN THE BUILDING CODE OF NEW YORK STATE.

2. THE TERM "INDICATED" SHALL MEAN "AS SHOWN ON CONTRACT DOCUMENTS (SPECIFICATIONS, DRAWINGS, AND RELATED ATTACHMENTS)" 3. THE TERM "PROVIDE" SHALL MEAN "TO FURNISH, INSTALL, AND CONNECT

COMPLETELY"

4. THE TERM "SIZE" SHALL MEAN ONE OR MORE OF THE FOLLOWING: "LENGTH. CURRENT AND VOLTAGE RATING, NUMBER OF POLES, NEMA SIZE, AND OTHER SIMILAR ELECTRICAL CHARACTERISTICS".

1. ELECTRICAL PLANS, DETAILS, AND ONE LINE DIAGRAMS SHOW THE GENERAL LOCATION AND ARRANGEMENT OF THE ELECTRICAL SYSTEM. THEY ARE DIAGRAMMATIC AND DO NOT SHOW ALL CONDUIT BODIES, CONNECTORS, BENDS, FITTINGS, HANGERS, AND ADDITIONAL PULL BOXES WHICH THE CONTRACTOR MUST PROVIDE TO COMPLETE THE ELECTRICAL SYSTEM.

ELECTRICAL PLANS AND DETAILS DO NOT SHOW ALL INTERFERENCES AND CONDITIONS, VISIBLE AND/OR HIDDEN, THAT MAY EXIST; THUS REQUIRING THE CONTRACTOR TO INSPECT AND SURVEY THE SPACE BEFORE PERFORMING THE WORK.

ALL EXTERIOR CONDUITS TO HAVE DUCT SEAL INSTALLED AT ALL ENDS, BOXES, WEATHERHEADS, PENETRATIONS TO INTERIOR SPACES, ETC. 2. DUCT BANKS SHALL NOT BE ROUTED DIRECTLY ABOVE OR BELOW

EXISTING/PROPOSED UTILITIES EXCEPT WHEN CROSSING. WHERE CROSSING EXISTING OR PROPOSED UTILITIES DUCT BANKS SHALL CROSS AT 90 DEGREE ANGLES. 3. ALL CONDUIT SYSTEMS EXPOSED TO TEMPERATURE DIFFERENTIALS, IN POTENTIAL CONDENSING ATMOSPHERES, EXTERIOR INSTALLED, OR INSTALLED UNDERGROUND SHALL HAVE PROVISIONS FOR DRAINING WATER OUT OF CONDUIT SYSTEMS. PROVIDE DRAIN IN CONDUIT SYSTEMS AT LOW POINTS, LOW POINT SHALL NOT BE AT EQUIPMENT OR DEVICE. A BREATHER SHALL BE PROVIDED AT THE HIGH POINT OF

UNDERGROUND UTILITIES

TO ANY EXCAVATION.

THE SYSTEM.

UNDERGROUND UTILITY LOCATIONS ARE NOT GUARANTEED, NOR IS THERE ANY GUARANTEE THAT ALL EXISTING UTILITIES WHETHER FUNCTIONAL OR ABANDONED WITHIN THE PROJECT AREA ARE SHOWN ON THESE DRAWINGS. 2. THE CONTRACTOR SHALL DETERMINE THE EXACT LOCATION OF ALL UNDERGROUND

UTILITIES BEFORE BEGINNING WORK & SHALL BE RESPONSIBLE FOR ALL DAMAGE RESULTING FROM HIS/HER WORK. 3. THE CONTRACTOR SHALL NOTIFY "DIG SAFELY NEW YORK" 1-800-962-7962 PRIOR **SYMBOLS**

LINEWEIGHT AND LINETYPE DESIGNATIONS EXISTING OR BY OTHERS UOI PROPOSED (TO BE PROVIDED BY THIS CONTRACT) UOI ——OHE— OVERHEAD ELECTRIC —UGE— UNDERGROUND ELECTRIC BASIC DRAWING SYMBOLS

<u>EQUIPMENT</u>

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(X)

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(T)

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AC

DED

GFI

TR

WP

48

(OC/C)

●_F

<u>LIGHTING</u>

FAN/BLOWER

PHOTOCELL

GENERATOR

THERMOSTAT

FLOW SWITCH

RECEPTACLES & DATA DEVICES

PUSH BUTTON (OPEN)

SIMPLEX RECEPTACLE

DUPLEX RECEPTACLE

QUADPLEX RECEPTACLE

DOUBLE DUPLEX RECEPTACLE

RECEPTACLES & DATA DEVICES - SUBSCRIPT DESIGNATIONS

INSTALLED ABOVE COUNTER

DEDICATED

TAMPER RESISTANT

LIGHTING CIRCUIT

SINGLE DEVICE WALL MOUNT DATA BOX

SINGLE DEVICE WALL MOUNT TELEPHONE BOX

LABEL ONE "TELEPHONE" AND ONE "DATA")

INDICATES GFCI PROTECTED RECEPTACLE

DUAL DEVICE WALL MOUNT BOX (TWO RJ45 OUTLETS,

CONTROL & INSTRUMENTATION DEVICES

MOTOR WITH HORSEPOWER

SOLAR PHOTOVOLTAIC PANEL

AUTOMATIC TRANSFER SWITCH

CONTROL DEVICE OR STATION, TYPE, ITEM NUMBER

SPECIAL RECEPTACLE, 4'AFF, NEMA CONFIGURATION AS NOTED.

SWITCHED DUPLEX RECEPTACLE OUTLET, SWITCH TOP HALF

INDICATES GFCI PROTECTED W/ IN-USE WEATHERPROOF COVER

(REFER TO LIGHTING FIXTURE SCHEDULE FOR FIXTURE TYPES)

D-DIMMER, K-KEY, P-PILOT, M-MOTION/OCCUPANCY SENSOR

LIGHT FIXTURE, LETTER INDICATES TYPE, 'EL' INDICATES EGRESS

NO. INDICATES MOUNTING HEIGHT, OTHER THAN 18" AFF

SWITCH: S-SINGLE POLE, 3-THREE WAY, 4-FOUR WAY

CEILING MOUNTED OCCUPANCY/MOTION SENSOR

LIGHT FIXTURE WITH EMERGENCY BATTERY PACK

TEMPERATURE ACTUATED SWITCH (OPEN)

TEMPERATURE ACTUATED SWITCH (CLOSED)

VARIABLE FREQUENCY DRIVE (VFD)

DB-01 UNDERGROUND DUCT BANK DESIGNATION (1)KEYED NOTE

 $\langle A1 \rangle$ FEEDER DESIGNATION CONTROL CIRCUIT DESIGNATION

REMOVALS REINFORCED CONCRETE DUCT BANK

CONCRETE DUCT BANK UNSWITCHED CONTINUATION CIRCUIT SWITCHED CONTINUATION CIRCUIT

CIRCUIT NUMBER HOME RUN 2#12,1#12GND IN 3/4"C TO A 20A,1P CIRCUIT BREAKER IN DESIGNATED PANEL UOI

SERVICE & DISTRIBUTION

UTILITY POLE $\overline{\mathsf{M}}$ SELF CONTAINED METER METER CABINET WITH REMOTE METER TRANSFORMER

_PANEL DESIGNATION

DELTA DISTRIBUTION SYSTEM WYE DISTRIBUTION SYSTEM

WIRING METHODS

GAS/WATERTIGHT PENETRATION INSULATED BUSHING OR CONDUIT STUB

 $\neg \mid \vdash$ CONDUIT UNION \Longrightarrow EXPANSION FITTING

SEAL OFF

FLEXIBLE CONNECTION COILED SLACK

CONTINUATION CABLE FLOAT PULL BOX, ITEM NUMBER

JUNCTION BOX

HAND HOLE, ITEM NUMBER CORD AND PLUG, AS INDICATED ON DWG

WIRING DIAGRAM

 $\sim \sim$

CONTACTOR (NO) CONTACTOR (NC)

OVERLOAD RELAY

RELAY

SOLENOID

LIGHTNING ARRESTOR DRAW-OUT FRAME

MATED CONNECTION

SWITCHES AND PROTECTIVE DEVICES CIRCUIT BREAKER

FUSE \sim AIR-BREAK SWITCH

MANUALLY GANG OPERATED DISCONNECTING SWITCH WITH ARCING HORNS

DISCONNECT SWITCH \longrightarrow \bigcirc FUSED DISCONNECT SWITCH

SWITCH (OPEN) SWITCH (CLOSED) 9 __ FUSE CUTOUT

GROUNDING

GROUND WITH DIRECT CONNECTION TO EARTH

GROUND ROD

ABBREVIATIONS

BW

CB

DS

DWG

PHASE LOCKED ROTOR AMPS LRA AMPERE LS LEVEL SENSOR ABOVE COUNTER LTS LIGHTS AIR COOLED CONDENSING UNIT MILLIAMP MΑ AMP FRAME MANUAL STARTER AFF ABOVE FINISHED FLOOR MAGNETIC ABOVE FINISHED GRADE MAXIMUM MECHANICAL CONTRACTOR AUTHORITY HAVING JURISDICTION MINIMUM CIRCUIT AMPACITY AHU AIR HANDLING UNIT MCA **ANNUNCIATOR** MAIN CIRCUIT BREAKER ANN AMERICAN NATIONAL STANDARDS INSTITUTE MOTOR CONTROL CENTER AMP TRIP MCP MAIN CONTROL PANEL AUTOMATIC TRANSFER SWITCH MDP MAIN DISTRIBUTION PANEL MAIN DISCONNECT SWITCH AUDIO/VISUAL AMERICAN WIRE GAUGE AWG MANUFACTURER ACROSS THE LINE METAL HALIDE AXL BOILER MOUNTING HEIGHT BATT BATTERY MINIMUM BENEATH FINISHED GRADE MOTOR STARTER BUILDING MOUNTED **BANDWIDTH** MANUAL TRANSFER SWITCH CONDUIT NEUTRAL CIRCUIT BREAKER NORMALLY CLOSED COMPACT FLUORESCENT CFL NATIONAL ELECTRIC CODE CHARACTERISTICS NATIONAL FIRE PROTECTION ASSOCIATION CHAR CKT CIRCUIT NOT IN CONTACT CURRENT LIMITING NIGHT LIGHT CLG CEILING NORMALLY OPEN COMBINATION STARTER POLE COMM COMMUNICATIONS PUMP CONC CONCRETE PUBLIC ADDRESS CONST CONSTRUCTION PE PULL BOX CONT CONTRACT PEND PENDANT CONTROL PANEL PHOTO CELL CURRENT TRANSFORMER PHASE COPPER PANEL DUCT BANK POWER PANEL **DECIBELS** PRI DEG DEGREE PROVIDED (FURNISHED AND INSTALLED) DISCONNECT DISC POUNDS PER SQUARE INCH DIVISION POTENTIAL TRANSFORMER DIV DISTRIBUTION PANEL PRESSURE TRANSDUCER DEPARTMENT OF TRANSPORTATION PACKAGED TERMINAL AIR CONDITIONING

DISCONNECT SWITCH POLYVINYL CHLORIDE DRAWING PWR POWER QTY QUANTITY EACH

ELECTRICAL CONTRACTOR RECEPTACLE RCPT EXHAUST FAN REQD REQUIRED ELECTRONIC

ELEC ELEV ELEVATOR ELECTROMAGNETIC INTERFERENCE

EQUIPMENT LIGHT FIXTURE, FLOOD ETC ET CETERA WALL PACK, OUTDOOR LIGHTING FIXTURE EUH

EXIT LIGHT FIXTURE, CEILING MOUNTED, ARROWS AS INDICATED, SHADING INDICATES FACE EXIT LIGHT FIXTURE, WALL MOUNTED, ARROWS AS INDICATED, SHADING INDICATES FACE

EMERGENCY LIGHTING UNIT, REMOTE BATTERY 1E EMERGENCY LIGHTING UNIT, INTEGRAL BATTERY

SITE LIGHTING FIXTURE, TWIN POLE MOUNTED SITE LIGHTING FIXTURE, SINGLE POLE MOUNTED

LIGHT FIXTURE, SPOT, CAN, OTHER

FIRE PROTECTION

FIRE ALARM SYSTEM, STROBE/HORN FIRE ALARM SYSTEM, STROBE ONLY FIRE ALARM SYSTEM, HORN

FIRE ALARM SYSTEM, PULL STATION FIRE ALARM SYSTEM, STROBE/BELL

FIRE ALARM SYSTEM, SPEAKER

FIRE ALARM SYSTEM, BEAM DETECTOR FIRE ALARM SYSTEM, BEAM DETECTOR RECEIVER

FIRE ALARM SYSTEM, SMOKE DETECTOR

H 135°F FIRE ALARM SYSTEM, HEAT DETECTOR

FIRE ALARM SYSTEM, CARBON MONOXIDE DETECTOR FACP FIRE ALARM SYSTEM, FIRE ALARM CONTROL PANEL FAAP

FIRE ALARM SYSTEM, FIRE ALARM ANNUNCIATOR PANEL FIRE ALARM SYSTEM, MAG. DOOR HOLDER(F=FLR.,C=CLG.,W=WALL)

RIGID GALVANIZED STEEL RUNNING LOAD AMPS ROOM RAPID START

EMERGENCY POWER SUPPLY RADIO TELEMETRY UNIT EMERGENCY POWER SUPPLY SYSTEM RTU REMOTE TERMINAL UNIT REDUCED VOLTAGE DRIVE SEC **SECONDARY**

ELECTRIC UNIT HEATER SPEC SPECIFICATION **EXTERIOR** SQUARE FIRE ALARM SOFT START SS FAAP FIRE ALARM ANNUNCIATION PANEL ST SHUNT TRIP STP FIRE ALARM CONTROL PANEL SHIELDED TWISTED PAIR

SUPPLIED FURNISHED BY SUPP FLUORESCENT SURF SURFACE FULL LOAD AMPACITY SW FLA SWITCH FLOOR SWBD SWITCHBOARD FLUORESCENT FLUOR SYM SYMMETRICAL

FURN FURNISH GENERAL CONTRACTOR GROUND FAULT CIRCUIT INTERRUPTER GFCI UG GROUND GND UGE

FAN SHUT-DOWN RELAY

HIGH PRESSURE SODIUM

LIGHTING PANEL

FEET

kCMIL

kW

HAND HOLE HIGH INTENSITY DISCHARGE HAND-OFF-AUTO SELECTOR SWITCH HORSEPOWER

HOT WATER HEATER HWHHERTZ INSTALLED BY **VFD INCHES**

WIRE **INDICATED** WITH INSTALLED INST WITHOUT JUNCTION BOX

WITHSTAND CURRENT RATING 1000 AMPERE INTERRUPTING CAPACITY WEATHERPROOF 1000 CIRCULAR MILS WELL PUMP

KILOWATT WATERTIGHT LIQUID CRYSTAL DISPLAY TRANSFORMER LIGHT EMITTING DIODE

UOI

TELEPHONE

THERMOSTAT

TELEVISION

UNDERGROUND

UNIT HEATER

VOLTAGE

VOLT AMPERES

UNDERGROUND ELECTRIC

UNDERWRITER'S LABORATORIES

UNLESS OTHERWISE INDICATED

UNSHIELDED TWISTED PAIR

VARIABLE FREQUENCY DRIVE

UNINTERRUPTIBLE POWER SUPPLY

TYPICAL

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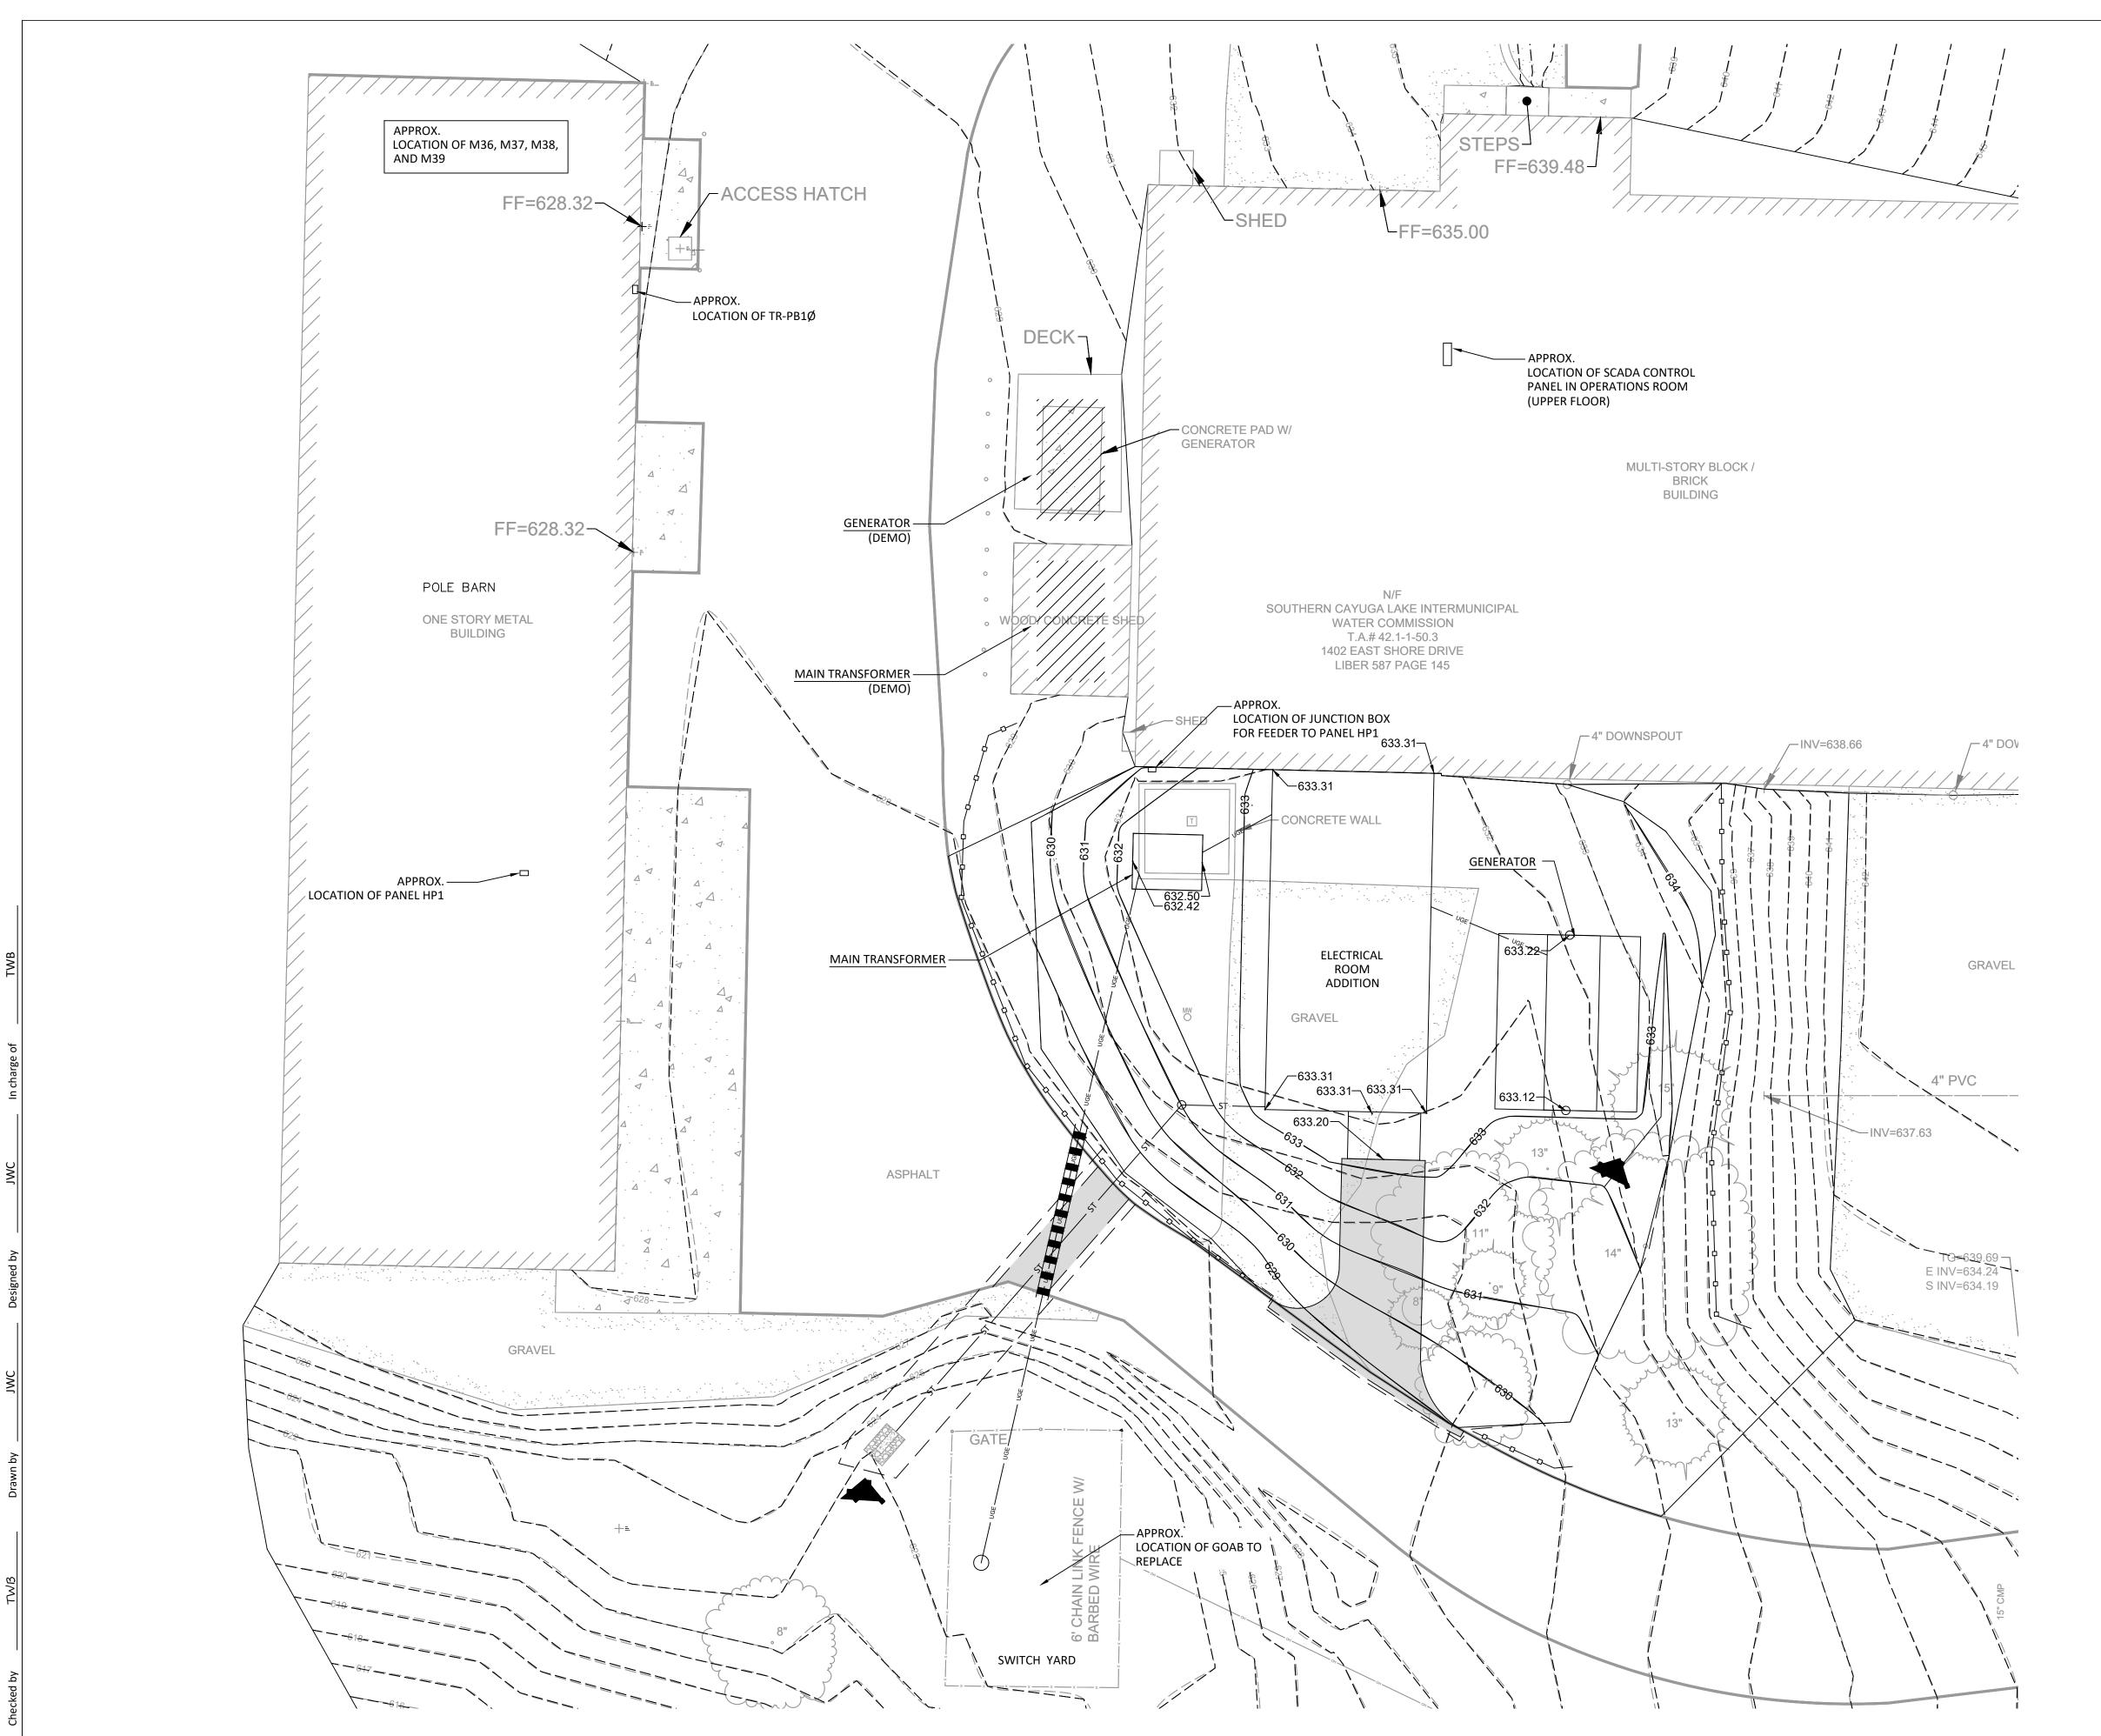
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REVISIONS

GENERAL NOTES, SITE PLAN

TRUE

NORTH

- 1. NOT ALL DUCT BANKS MAY BE SHOWN. PROVIDE ALL DUCT BANKS IN ACCORDANCE WITH
- 2. DUCT BANKS SHALL NOT BE LOCATED ABOVE OR BELOW OTHER SYSTEMS EXCEPT WHERE CROSSING. PROVIDE CROSSINGS AS NEAR TO PERPENDICULAR
- APPROXIMATE OR ANTICIPATED LOCATIONS. FIELD VERIFY ALL LOCATIONS AND ROUTE DUCT BANKS
- 4. DUCT BANKS SHALL BE CONCRETE WHERE LOCATED BENEATH OR WITHIN 5' OF PAVED ROADS, ACCESS ROADS, PARKING LOTS, OR OTHER DRIVE AREAS.
- BANKS.
- 7. SEAL ALL PENETRATIONS TO BUILDINGS WATERTIGHT.

APPLICABLE PLANS AND DETAILS.

AS FEASIBLE.

3. DUCT BANKS AND STRUCTURES SHOWN ARE AS REQUIRED PER INTENT OF PLANS.

- 5. PROVIDE ALL TRENCHING REQUIRED FOR DUCT
- 6. PROVIDE COMPLETE SITE RESTORATION FOR ALL
- DUCT BANKS.




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Sheet Number E101

Project Number




IS ON A HOUSEKEEPING PAD THAT WAS POURED ON TOP OF THE EXISTING FLOOR.

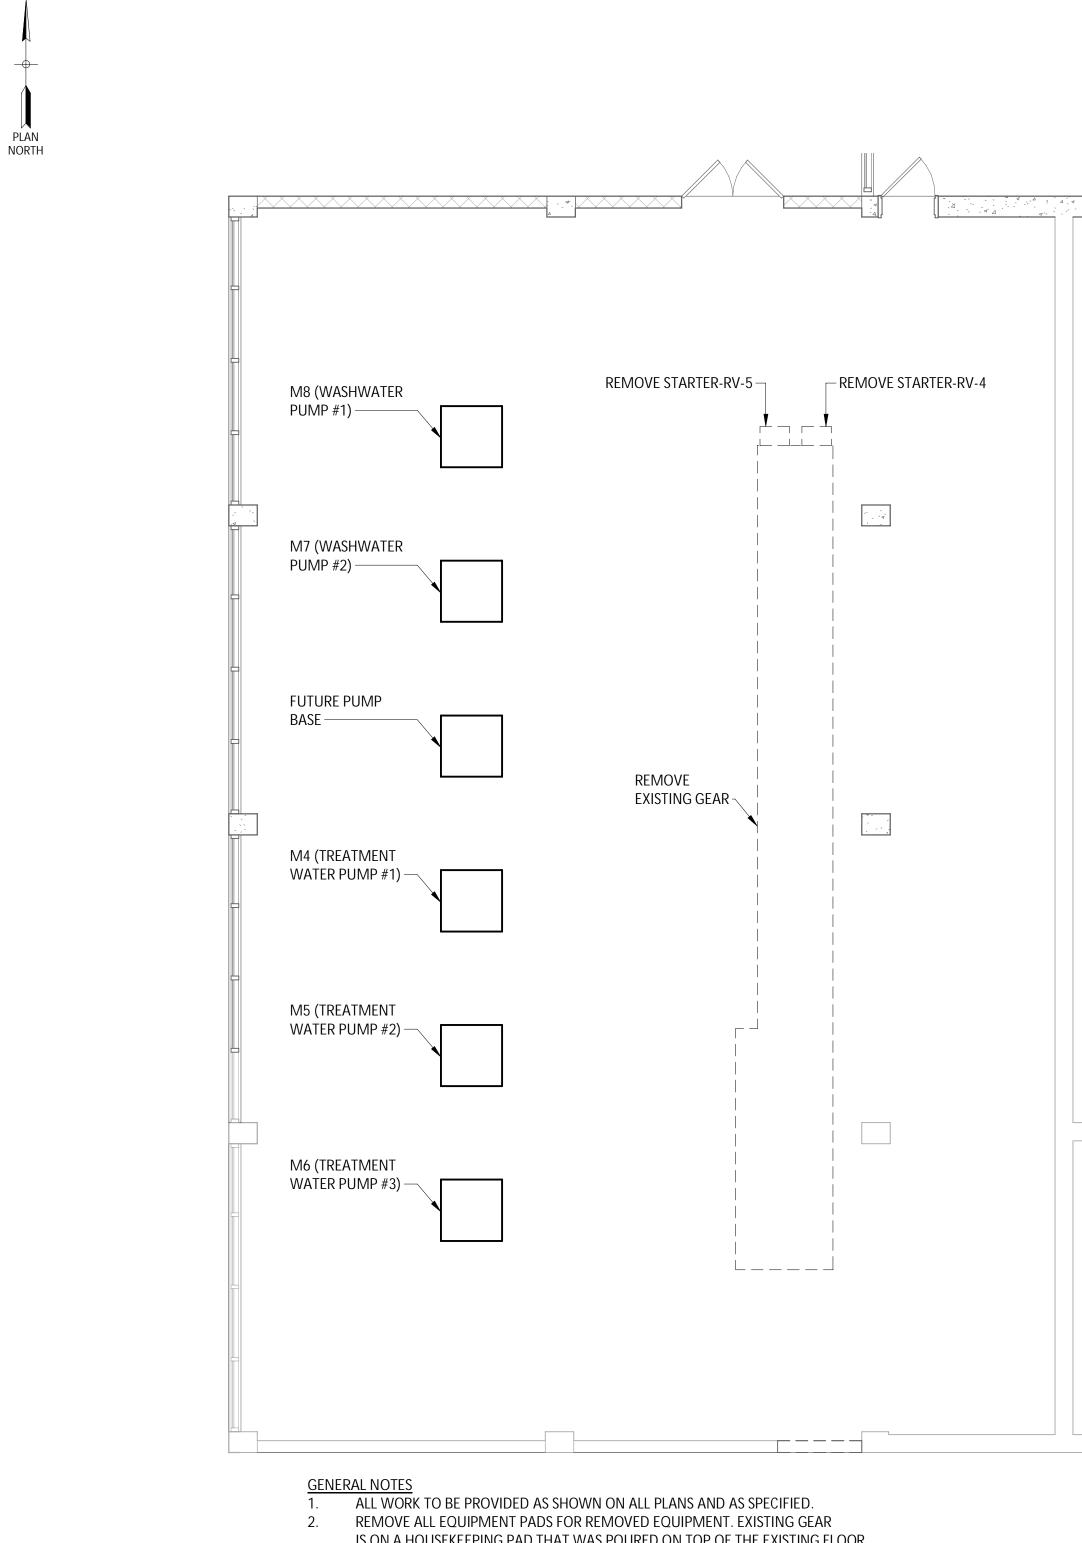REMOVE PAD AND CUT/GRIND ANY DOWELS OR PROJECTIONS FLUSH. SEAL ALL CONDUITS.

PUMP ROOM DEMOLITION PLAN

SCALE: 3/16" = 1'-0"

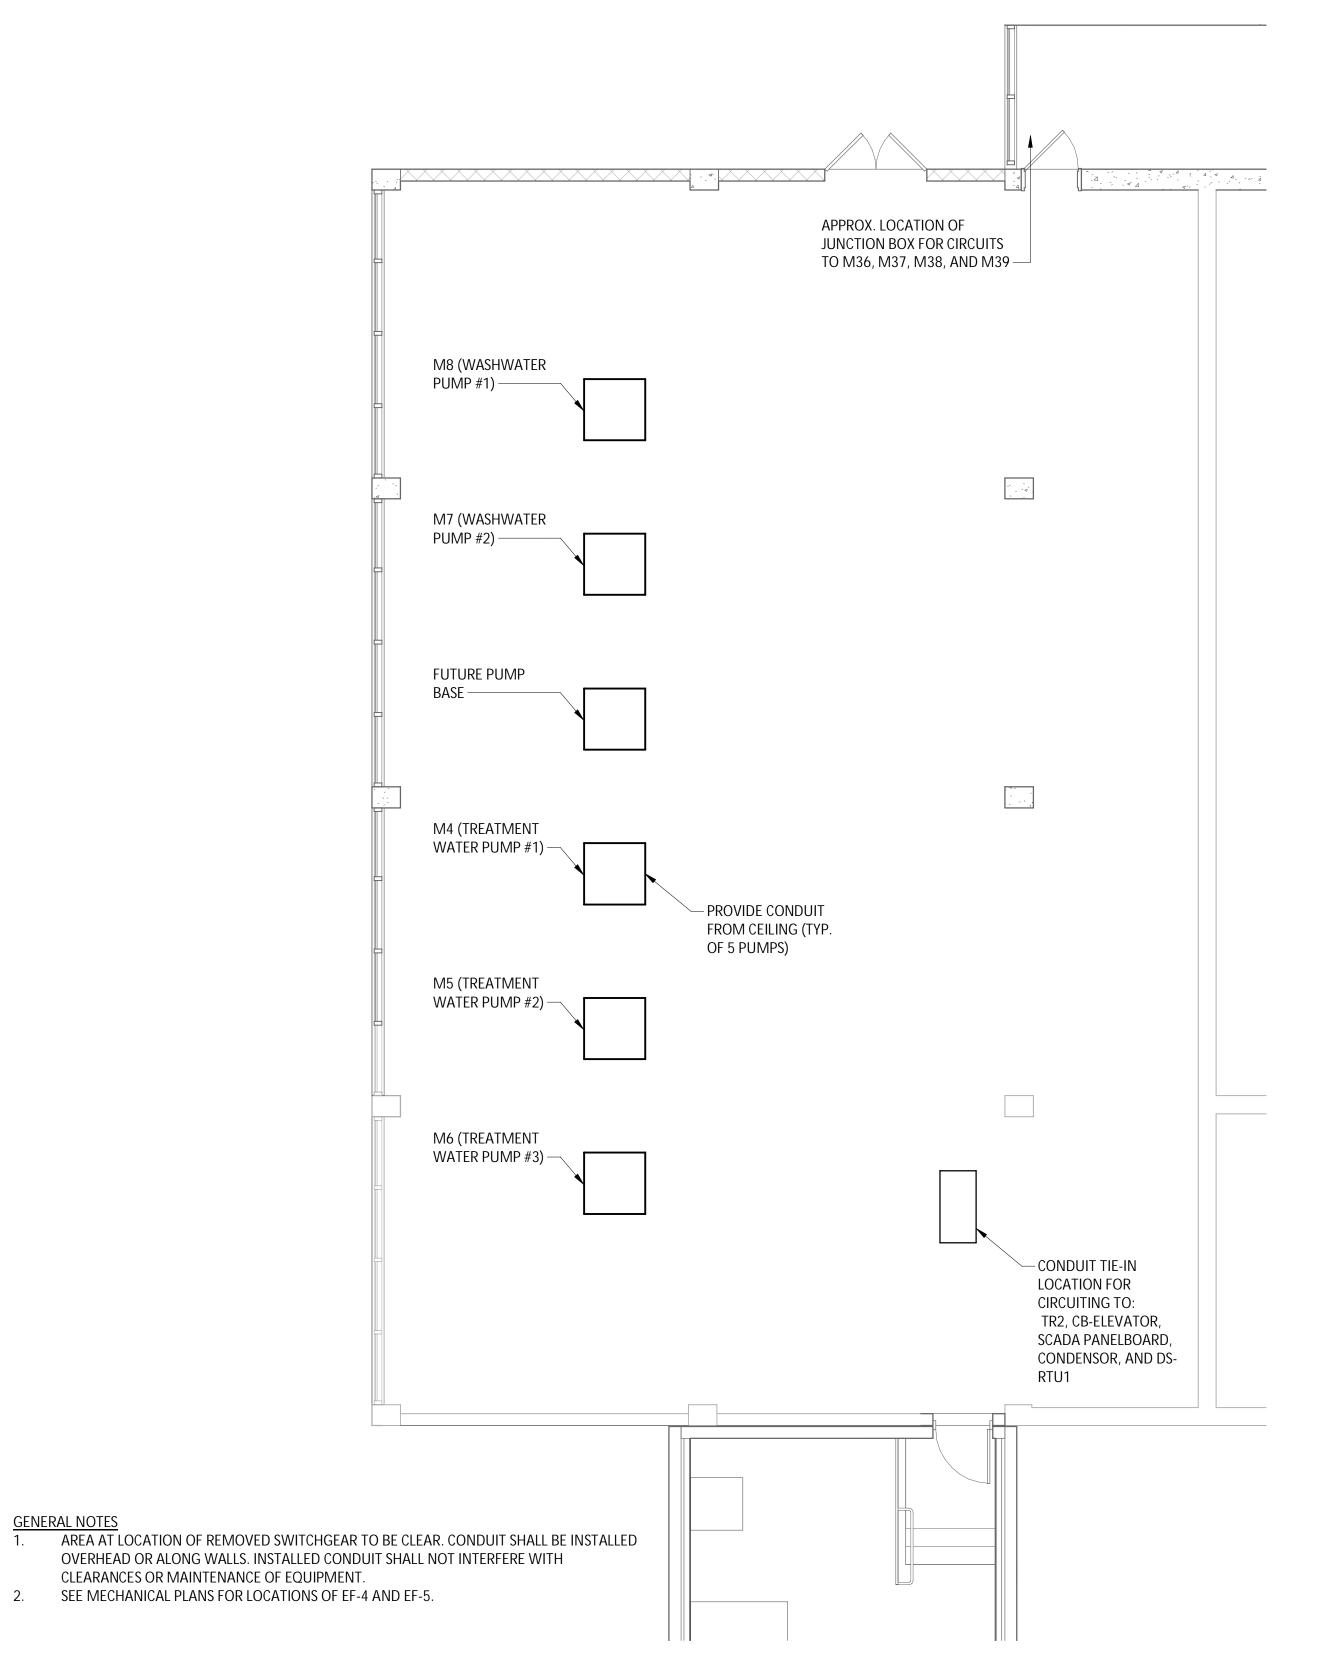

PUMP ROOM ELECTRICAL FLOOR PLAN

GENERAL NOTES

SCALE: 3/16" = 1'-0"

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REVISIONS

PUMP ROOM FLOOR PLANS


SOUTHERN CAYUGA LAKE INTERMUNICIPAL WATER COMMISSION BOLTON POINT WATER TREATMENT FACILITY ELECTRICAL UPGRADES




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Sheet Number E102



ELECTRICAL ROOM ADDITION FLOOR PLAN SCALE: 1/4" = 1'-0"

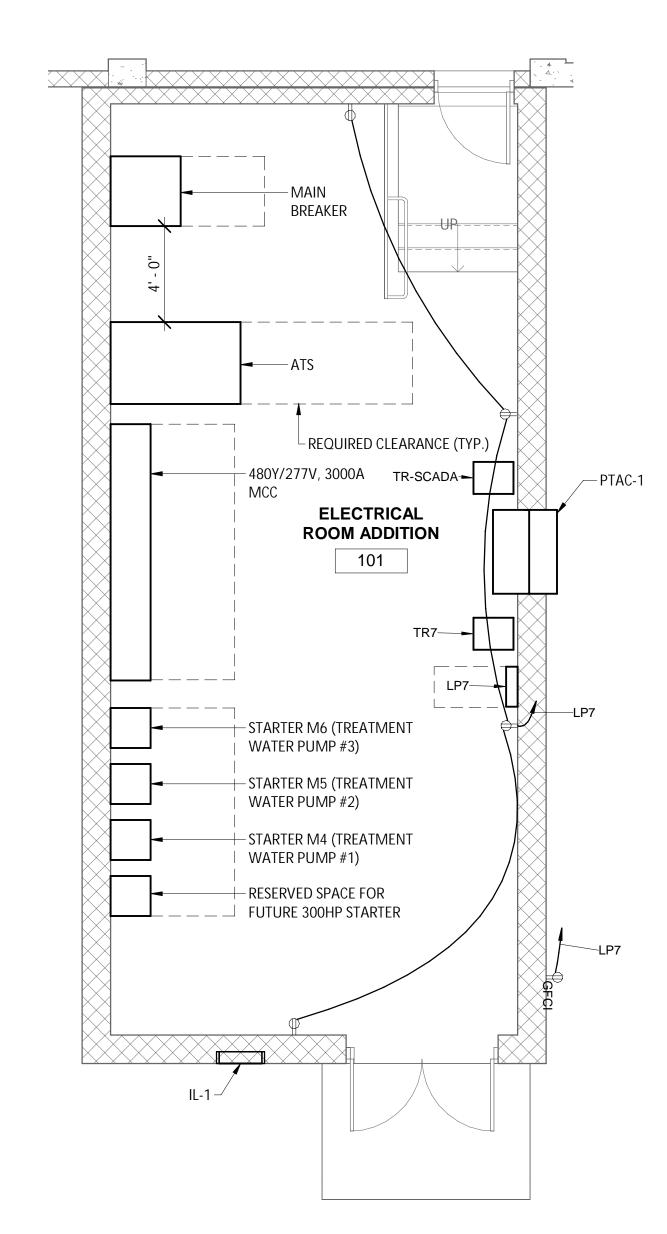

CIRCUIT ALL EMERGENCY AND EXIT LIGHTING TO UNSWITCHED PORTION

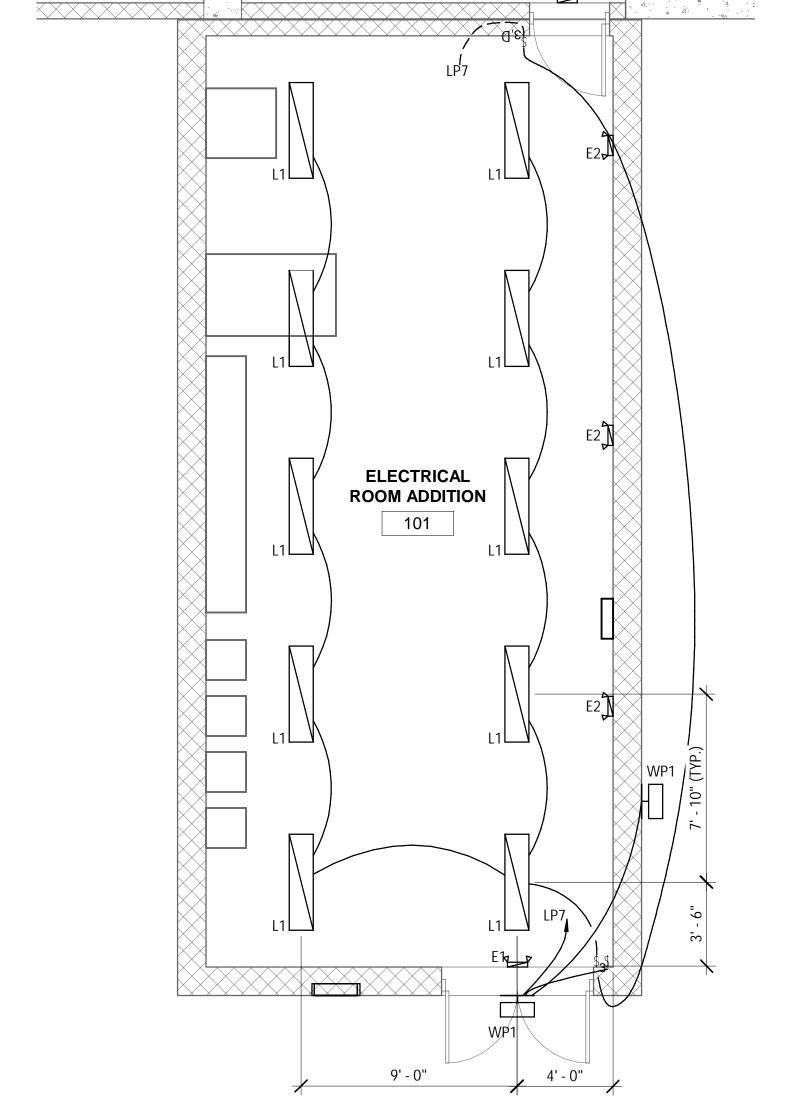OF NEAREST ROOM LIGHTING CIRCUIT.

2. TYPE L1 LIGHTS TO BE INSTALLED AT APPROX. HEIGHT OF 12'-0" AFF.

ELECTRICAL ROOM ADDITION LIGHTING PLAN

SCALE: 1/4" = 1'-0"


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REVISIONS

ANS

ADDITION FLOOR PL


ROOM ELECTRICAL

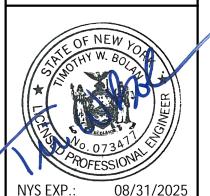


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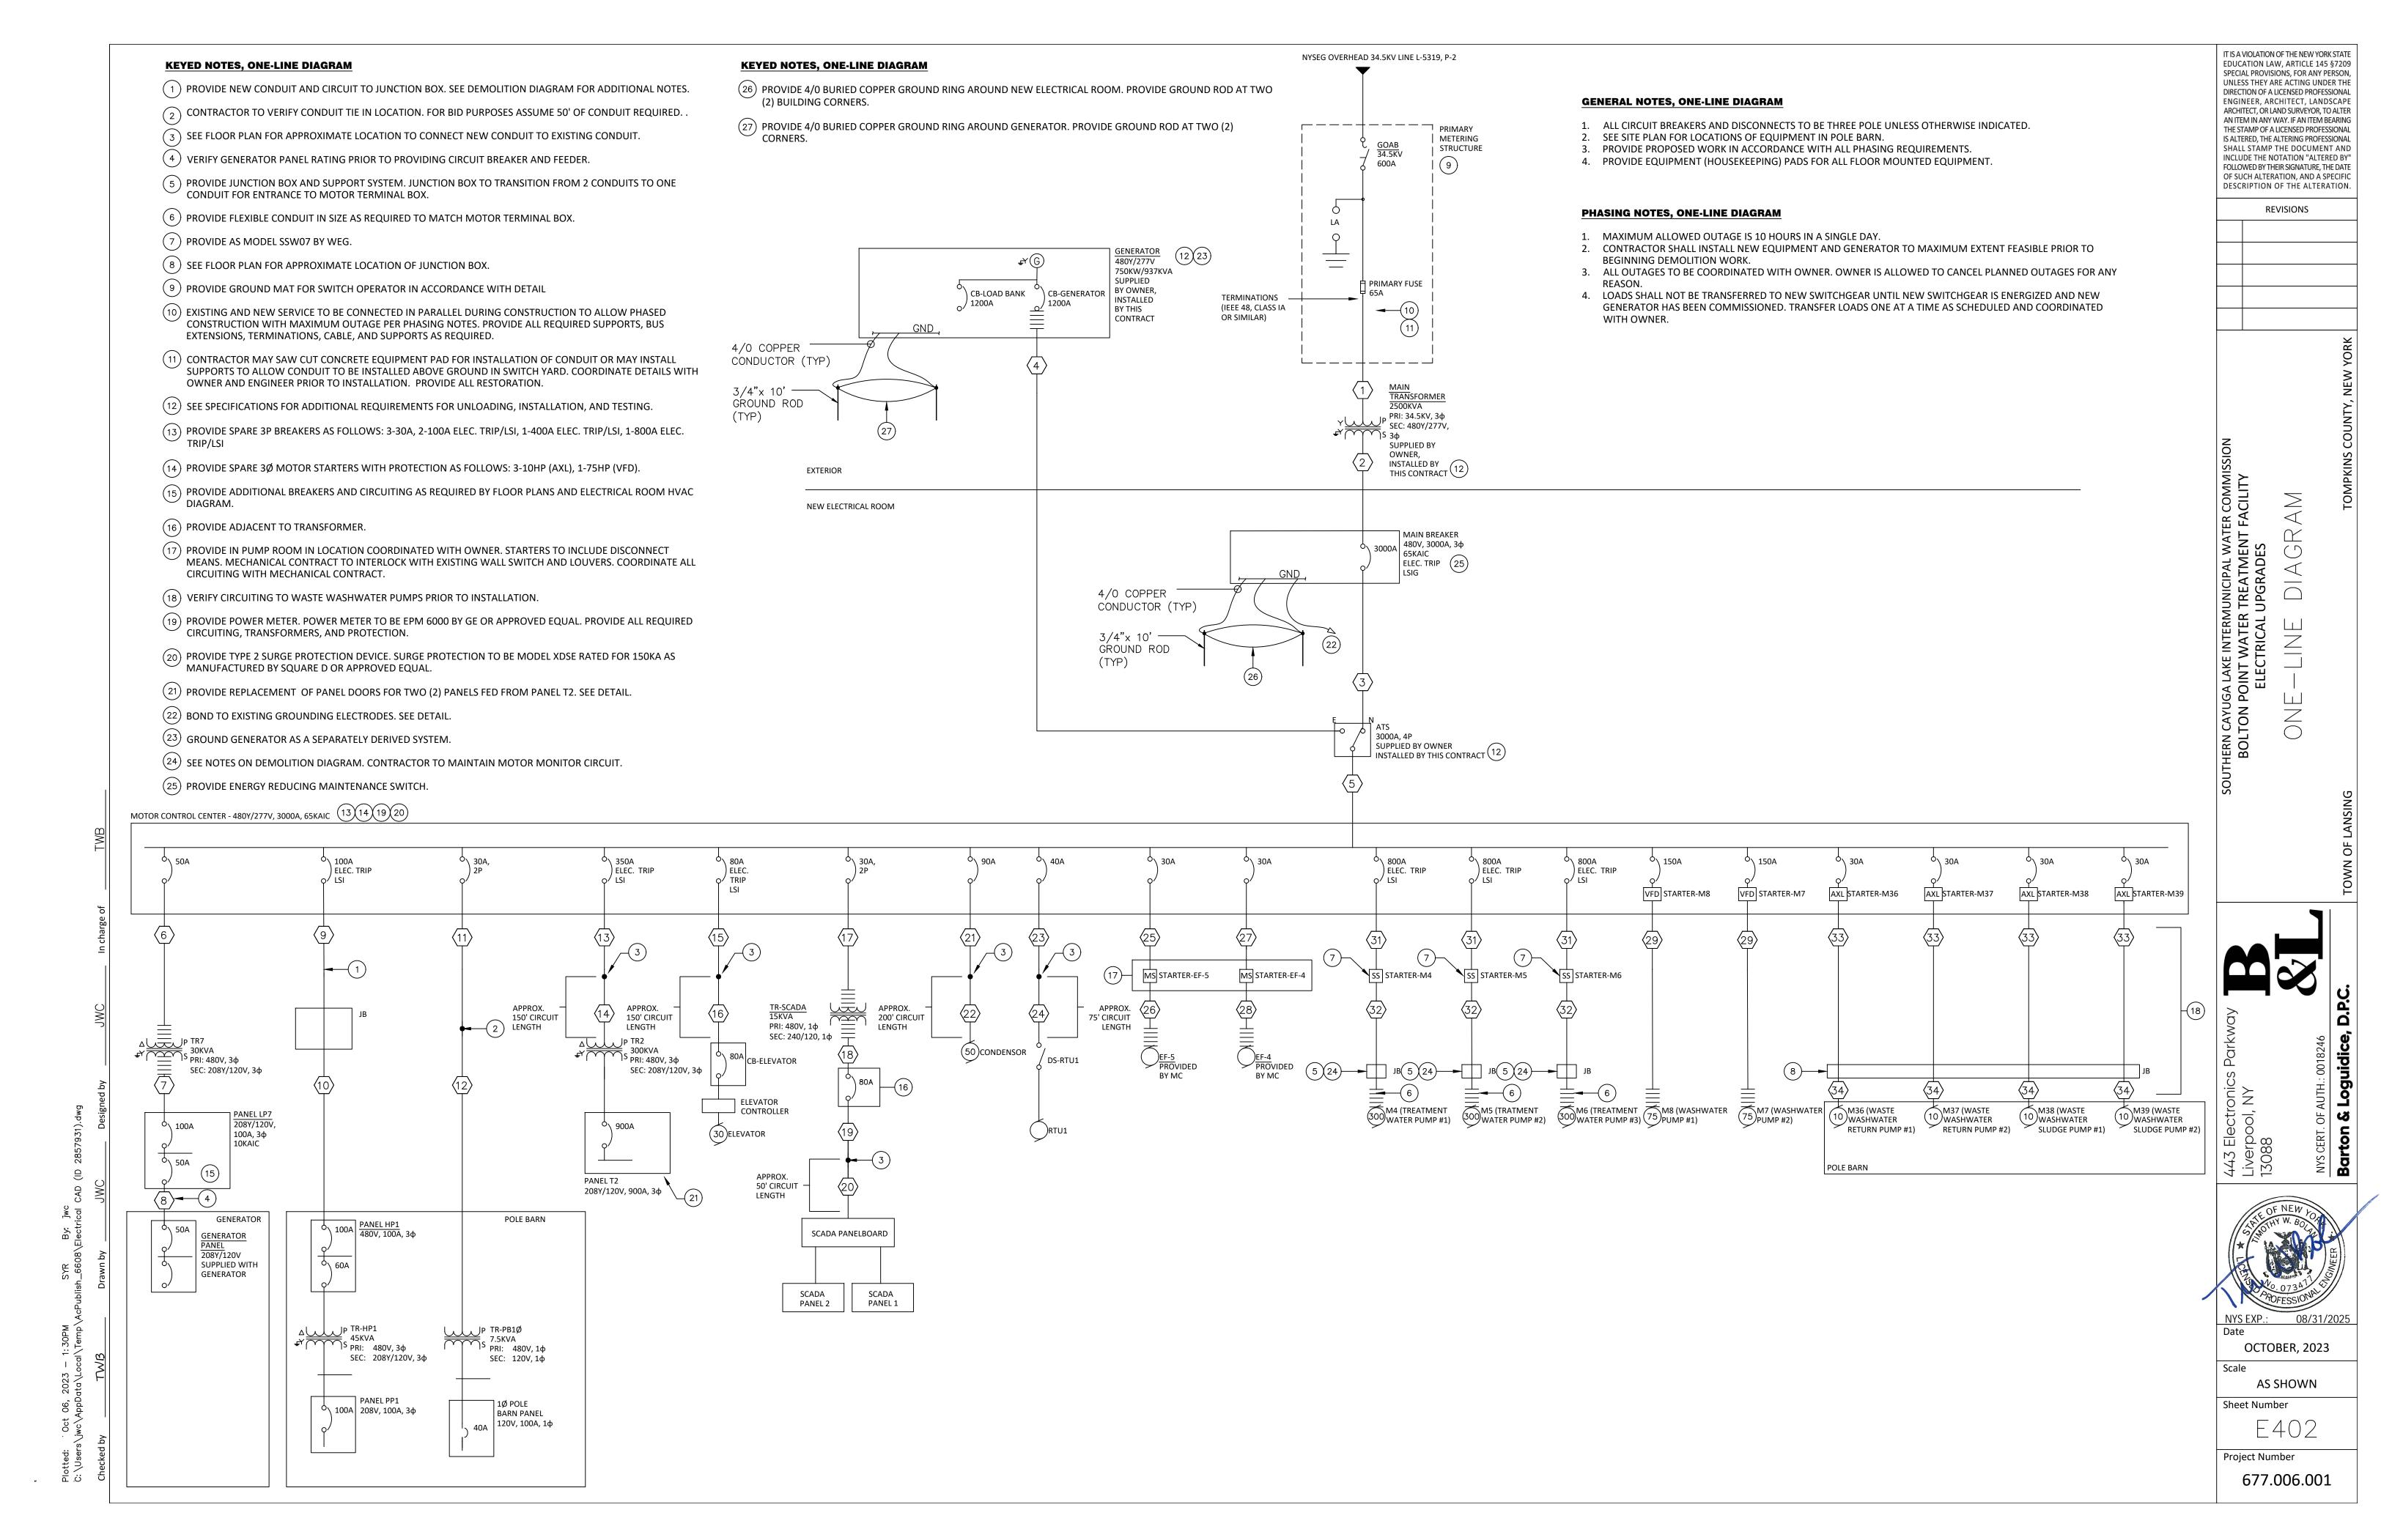
IT IS A VIOLATION OF THE NEW YORK STATE

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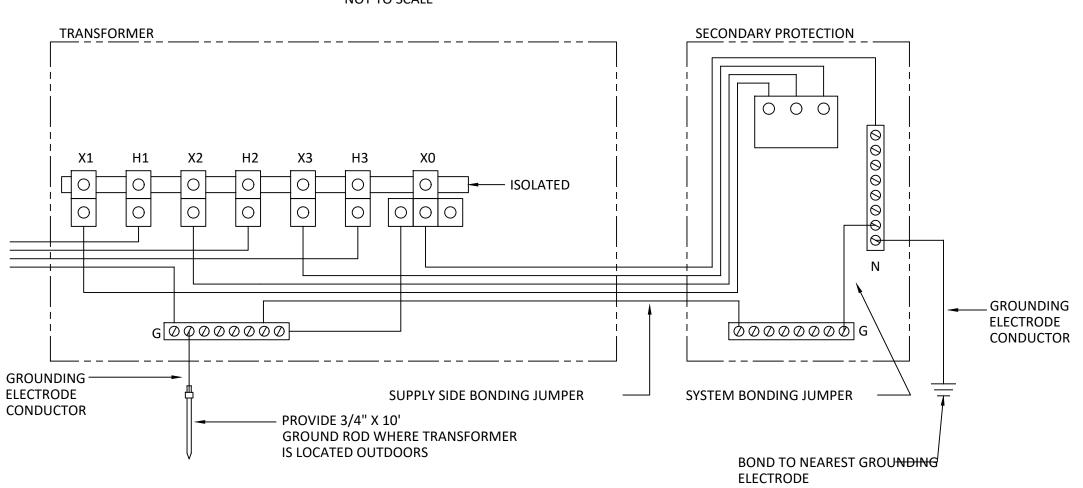
AS SHOWN

E401

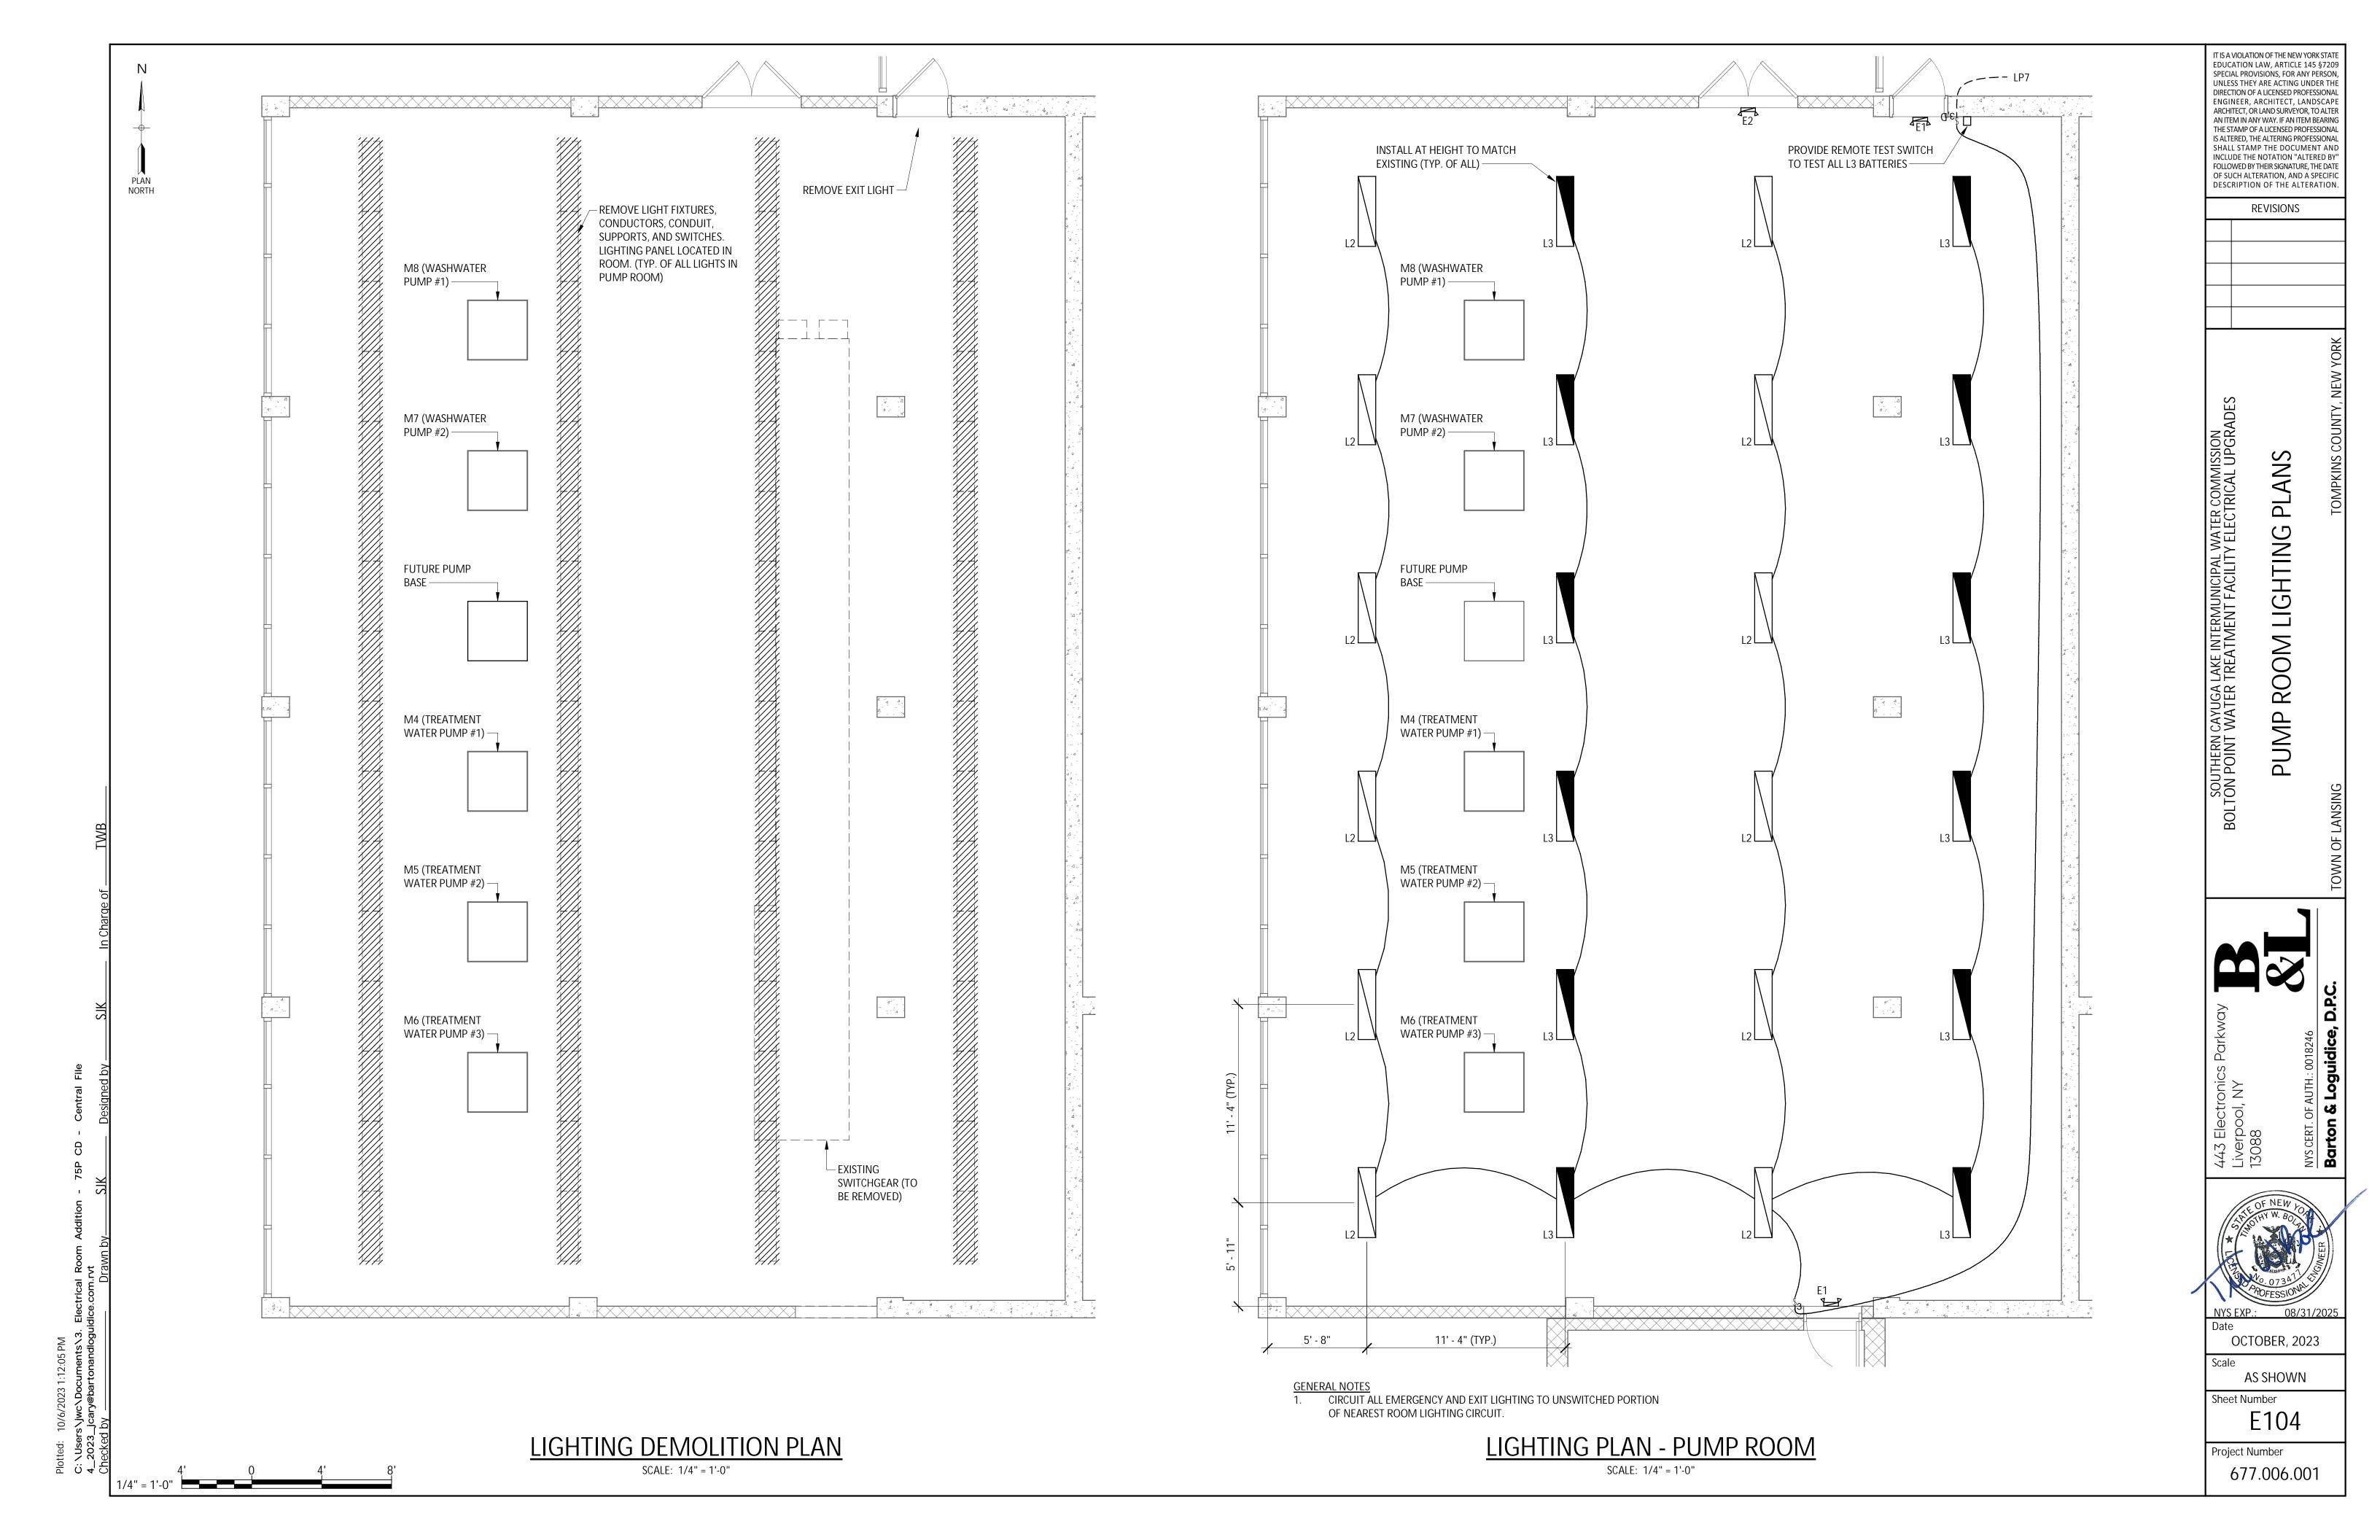

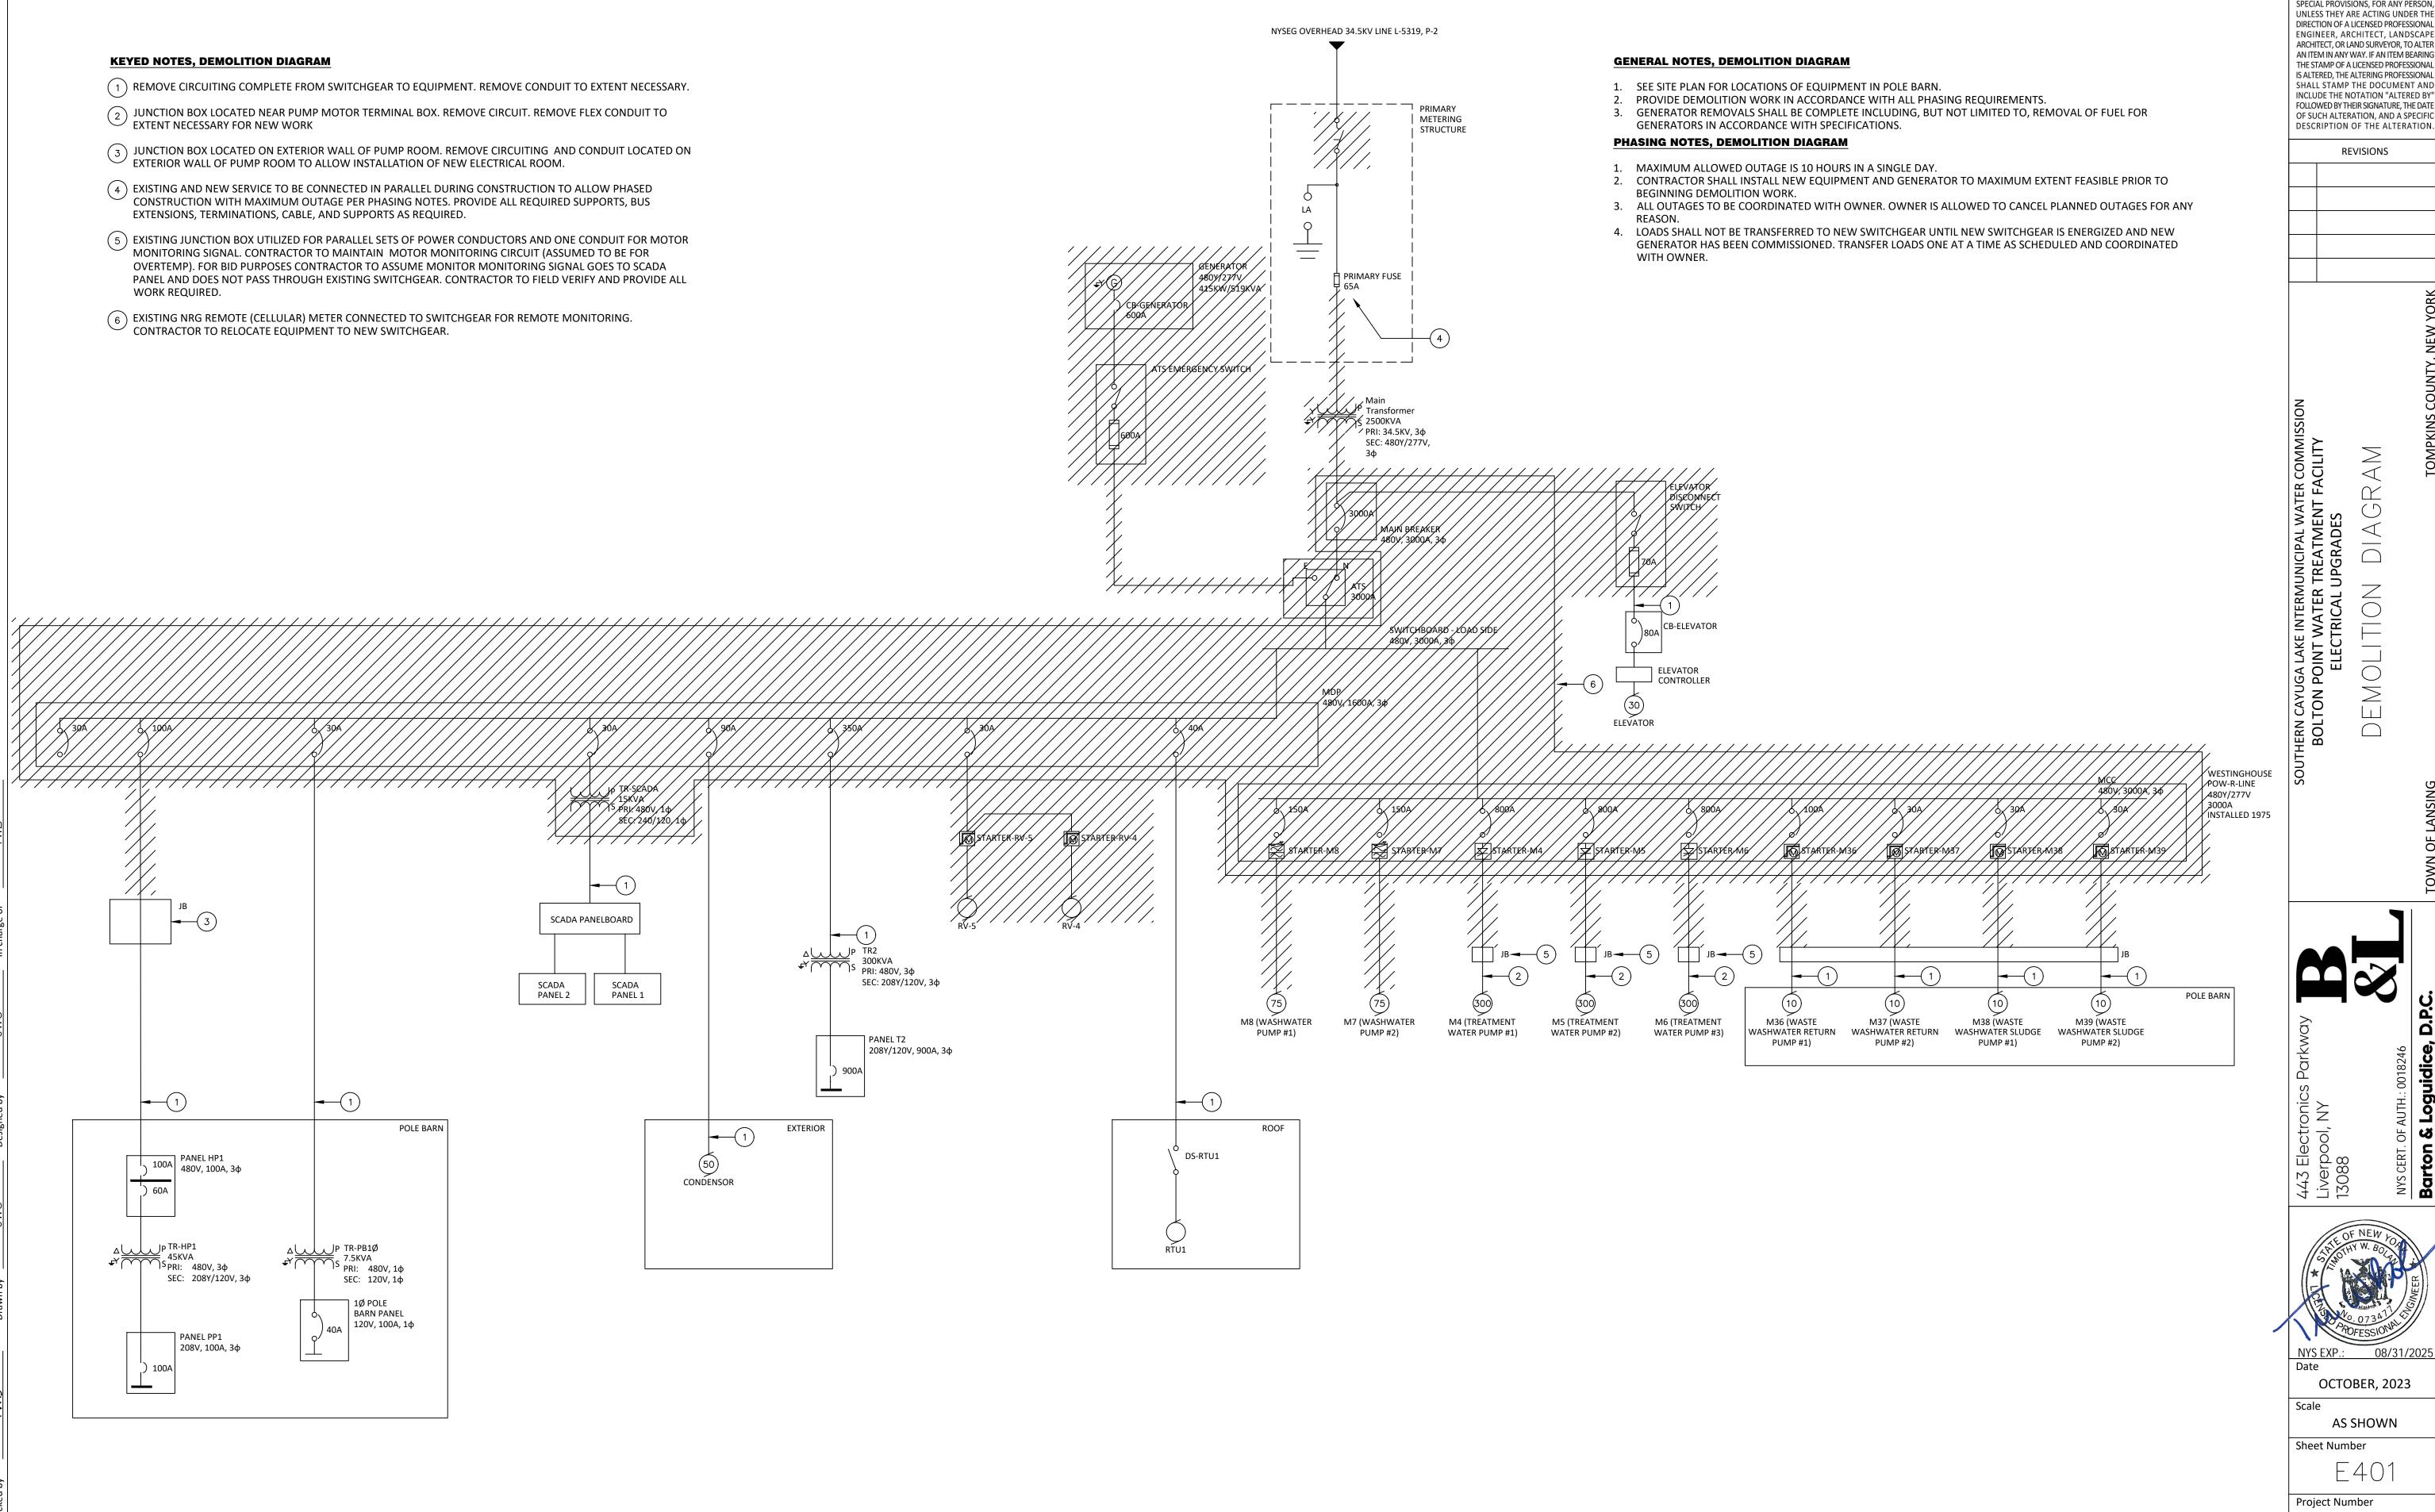- 1. BOND ALL NORMAL AND EMERGENCY EQUIPMENT TO GROUND RING.
- 2. BOND ALL EQUIPMENT TO GROUND AS REQUIRED BY MANUFACTURER. 3. NOT ALL GROUNDING SHOWN. PROVIDE ADDITIONAL GROUNDING AS REQUIRED PER
- SPECIFICATIONS AND NEC. 4. ALL GROUND CONDUCTORS SHALL BE 4/0kCMIL COPPER, U.O.I.

TYPICAL SERVICE ENTRANCE GROUNDING




GENERAL NOTES TRANSFORMER GROUNDING DETAIL


SUPPLY SIDE BONDING JUMPER, SYSTEM BONDING JUMPER, AND GROUNDING ELECTRODE CONDUCTOR TO BE PROVIDED AND SIZED IN ACCORDANCE WITH NEC TABLE 250.66 UNLESS OTHERWISE INDICATED.

TRANSFORMER GROUNDING DETAIL

NOT TO SCALE

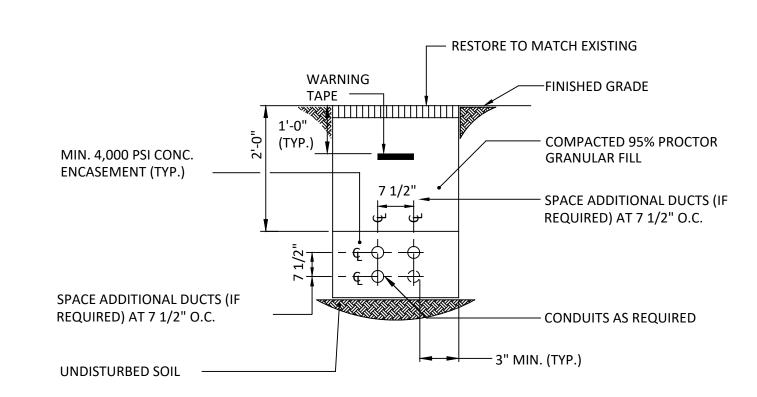

CONCRETE DUCT BANK SECTION NOT TO SCALE

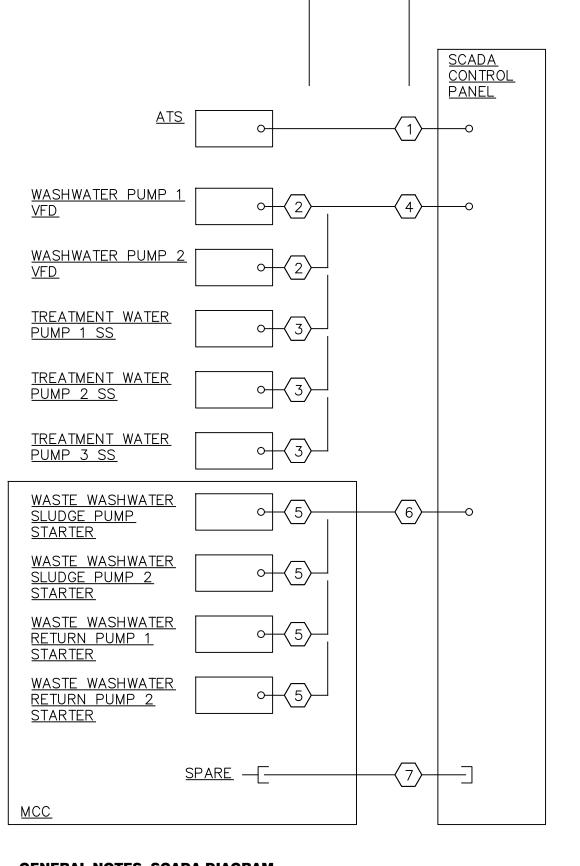

ELECTRICAL ROOM

OPERATIONS OFFICE


GENERAL NOTES, SCADA DIAGRAM

- SEE SITE PLAN FOR LOCATION OF SCADA CONTROL PANEL. TERMINATIONS AT SCADA PANEL TO BE PROVIDED BY OWNER THROUGH THEIR SCADA INTEGRATOR. COORDINATE ALL WORK WITH OWNER.
- 3. ALL EQUIPMENT & CIRCUITING SHOWN AS BASIS OF DESIGN. CONTRACTOR SHALL CONFIRM ALL CIRCUITING WITH APPROVED EQUIPMENT SHOP


CIRCUIT SCHEDULE, SCADA DIAGRAM

- $\langle 1 \rangle$ 6#14 IN 3/4"C
- 2 6#14, 2#18STP IN 3/4"C
- (3) 6#14 IN 3/4"C
- 4 30#14, 4#18STP IN 1 1/.2"C
- 5 4#14
- 6 16#14 IN 3/4"C
- 7 PULL STRING IN 1"C

SCADA DIAGRAM NOT TO SCALE

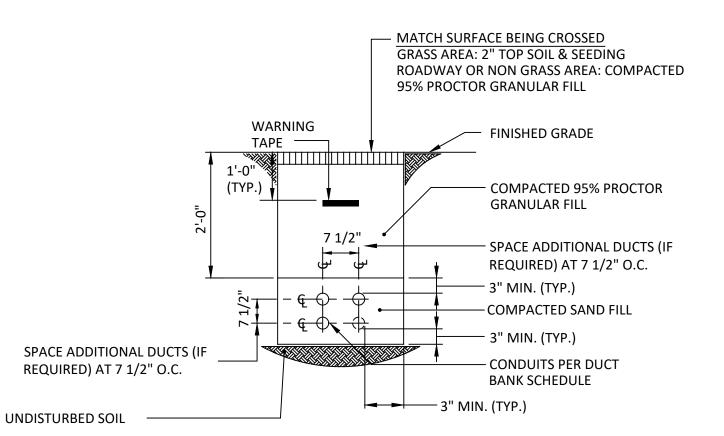

SAND FILL DUCT BANK SECTION

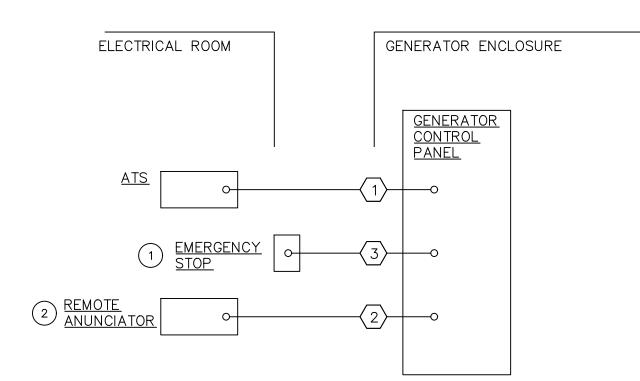

GENERAL NOTES, GENERATOR CONTROL DIAGRAM

- 1. CONTRACTOR TO PROVIDE A COMPLETE OPERATIONAL SYSTEM AS COORDINATED WITH GENERATOR AND TRANSFER SWITCH.
- 2. SEE ONE-LINE DIAGRAM FOR ADDITIONAL INFORMATION.
- 3. ALL EQUIPMENT & CIRCUITING SHOWN AS BASIS OF DESIGN. CONTRACTOR SHALL CONFIRM ALL CIRCUITING WITH APPROVED EQUIPMENT SHOP DRAWINGS.


KEYED NOTES, GENERATOR CONTROL DIAGRAM

- 1) SUPPLIED WITH GENERATOR. INSTALL ON EXTERIOR WALL OF CONTROL BUILDING IN LOCATION
- 2 SUPPLIED WITH GENERATOR. INSTALL IN ELECTRICAL ROOM IN LOCATION COORDINATED WITH

CIRCUIT SCHEDULE, GENERATOR CONTROL DIAGRAM

- $\langle 1 \rangle$ 14#14 IN 1"C
- (2) 1#18STP IN 3/4"C
- (3) 2#14 WITH 1#14G IN 3/4"C

GENERATOR CONTROL DIAGRAM NOT TO SCALE

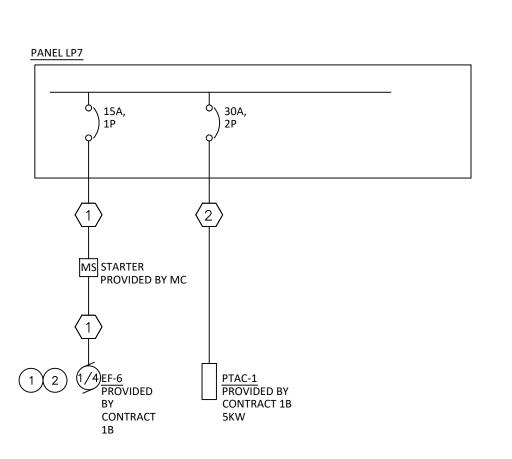

CIRCUIT SCHEDULE, ELECTRICAL ROOM HVAC DIAGRAM

- 1 2#12,1#12G IN 3/4"C
- (2) 2#8,1#10G IN 3/4"C

KEYED NOTES, ELECTRICAL ROOM HVAC DIAGRAM

- (1) EF-6 CONTROLLED BY WALL SWITCH PROVIDED BY CONTRACT 1B.
- EF-6 INTERLOCKED WITH IL-1 BY MECHANICAL CONTRACTOR. ALL (2) CIRCUITING FOR IL-1 BY CONTRACT 1B.

ELECTRICAL ROOM HVAC DIAGRAM

NOT TO SCALE

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UTHERN CAYUGA LAKE INTERMUNICIPAL WATER COMM BOLTON POINT WATER TREATMENT FACILITY ELECTRICAL UPGRADES

OCTOBER, 2023

AS SHOWN

Sheet Number E403


Project Number

GENERAL NOTES, EQUIPMENT PAD DETAIL 1. L = LENGTH OF EQUIPMENT BASE. W = WIDTH OF EQUIPMENT BASE. T = PAD THICKNESS.

2. ANCHOR EQUIPMENT TO PAD AS DIRECTED BY EQUIPMENT MANUFACTURER.

EQUIPMENT PAD DETAIL

NOT TO SCALE

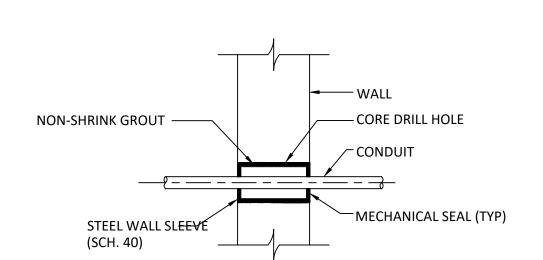

TYPICAL WALL CONDUIT **PENETRATION** NOT TO SCALE






GENERAL NOTES, PANEL DOOR REPLACEMENT DETAIL

- 1. CONTRACTOR SHALL REPAIR OR REPLACE TWO (2) PANEL DOORS TO ORIGINAL
- 2. PANELS ARE AS SHOWN. PANELS ARE WESTINGHOUSE TYP B10B 42-CIR. 3. PANEL DOORS MAY BE REPAIRED, REPLACED WITH NEW OLD STOCK, OR REPLACED
- WITH FABRICATED DOORS. 4. DOORS SHALL BE SECURED AS ORIGINAL.


PANEL DOOR REPLACEMENT DETAIL


NOT TO SCALE

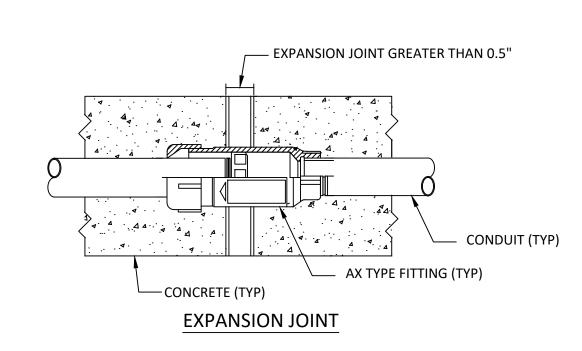

GENERAL NOTES, EXPANSION FITTING DETAIL

- 1. PROVIDE AN EXPANSION FITTING AT ALL EXPANSION JOINTS GREATER THAN 0.5" AND AS OTHERWISE INDICATED.
- 2. PROVIDE AN EXPANSION AT ALL RISERS FROM GRADE.
- 3. AX FITTING SHALL BE MODEL AX AS MANUFACTURED BY O-Z GEDNEY OR APPROVED EQUAL.
- 4. PROVIDE ALL REQUIRED BONDING JUMPERS, BOTH INTERNAL AND EXTERNAL.

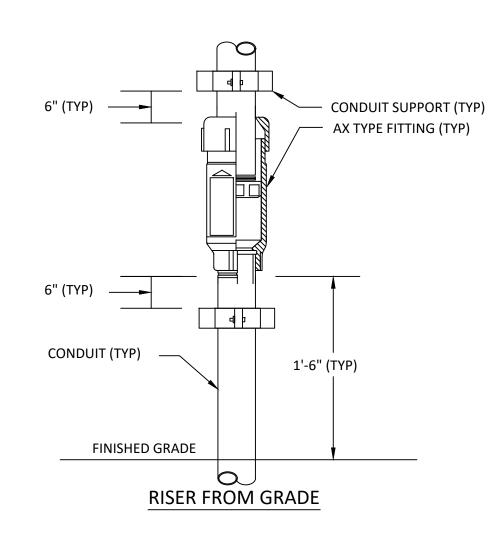

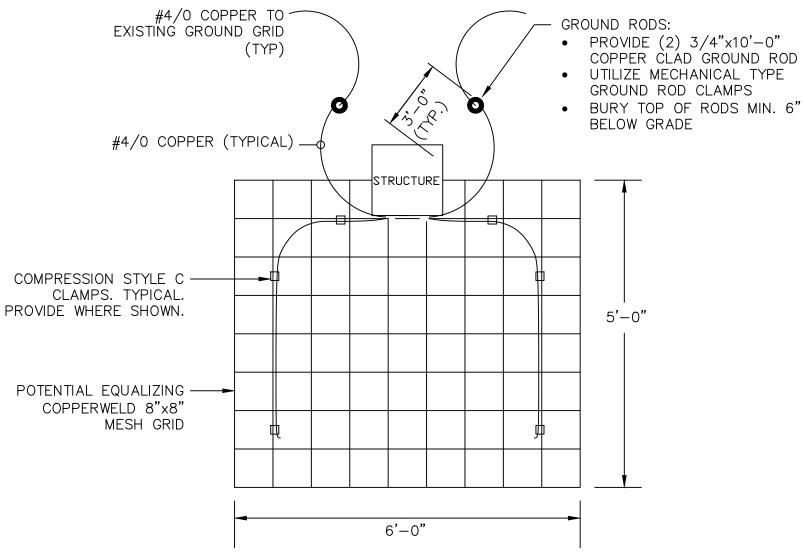

GENERAL NOTE, GROUND MAT DETAIL

1. INSTALL COPPER GROUNDING MAT ON EXISTING CONCRETE PAD.


GROUND MAT DETAIL NOT TO SCALE

CONDUIT CONNECTIONS

NEMA 4X PULLBOX INTERIOR (TYP) EXTERIOR (TYP) CONDUIT, SIZED PER NEC LOCATE AS REQUIRED. PROVIDE DÚCT SEAL AT ALL CONDUIT ROUTED TO/FROM INTERIOR LOCATIONS EQUIPMENT OR ENCLOSURE DRAIN, COOPER TYPE CD CONDUIT, AS BREATHER/DRAIN, OR APPROVED EQUAL REQUIRED. COOPER TYPE ACD ABOVE GRADE DRAIN LOCATION OR APPROVED EQUAL CONDUIT EQUIPMENT CABLE OR DEVICE - CONDUIT, ALL BUSHING CONDUIT LOCATED IN WET LOCATIONS (OUTDOORS, BELOW GROUND, ETC.) SHALL ENTER EXIT CONDUIT AT BOTTOM OF EQUIPMENT, DEVICES, AND PANELS.


EXPANSION FITTING DETAIL

NOT TO SCALE

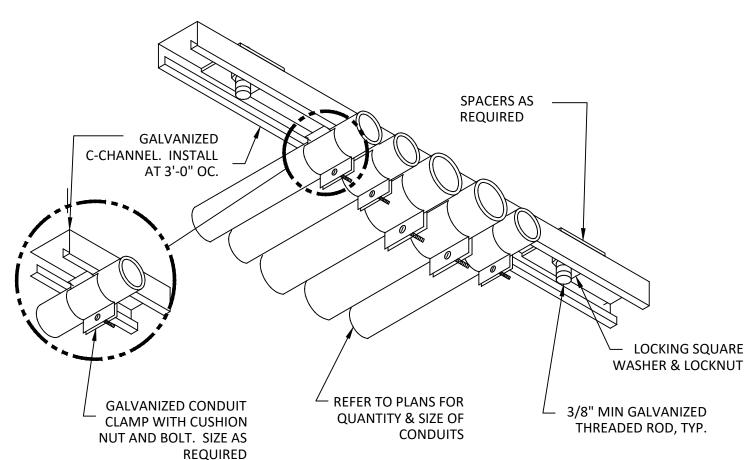

CONDUIT SUPPORT DETAIL

NOT TO SCALE

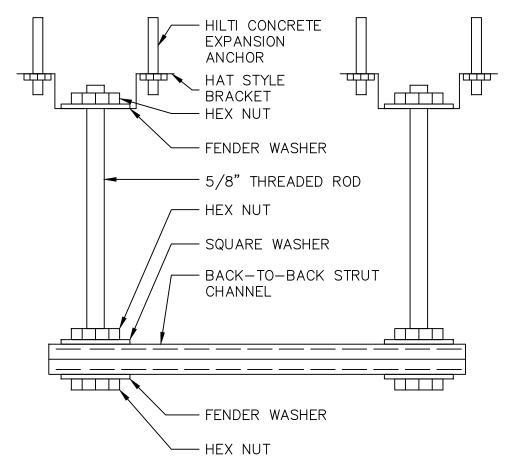

GENERAL NOTES, CEILING MOUNTED SUPPORT DETAIL

1. GALVANIZED CONDUIT CLAMP TO SECURE CONDUIT TO STRUT. SUSPENDED CONDUIT SUPPORT

NOT TO SCALE

CABLE CONNECTIONS GENERAL NOTES, TYPICAL CONDUIT DRAIN AND BREATHER DETAILS

- 1. ALL CONDUIT SYSTEMS EXPOSED TO TEMPERATURE DIFFERENTIALS, IN POTENTIAL CONDENSING ATMOSPHERES, EXTERIOR INSTALLED, OR INSTALLED UNDERGROUND SHALL HAVE PROVISIONS FOR DRAINING WATER OUT OF CONDUIT SYSTEMS. PROVIDE DRAIN IN CONDUIT SYSTEMS AT LOW POINTS, LOW POINT SHALL NOT BE AT EQUIPMENT OR DEVICE. A BREATHER SHALL BE PROVIDED AT THE HIGH POINT OF THE SYSTEM.
- PROVIDE ALL REQUIRED JUNCTION BOXES AT DRAIN POINTS. 3. CONDUIT DRAINS SHALL BE LOCATED AT EXTERIOR LOCATIONS. PROVIDE PVC PIPE TO EXTEND DRAIN SYSTEMS TO EXTERIOR LOCATIONS WHERE
- **REQUIRED** 4. CONDUIT SYSTEMS PITCHED TOWARD HANDHOLES OR ELECTRICAL MANHOLES SHALL BE CONSIDERED TO HAVE PROVISIONS FOR DRAINING WATER.
- 5. EQUIPMENT SHOWN IS FOR UNCLASSIFIED LOCATIONS. PROVIDE EQUIPMENT RATED FOR THE CLASSIFICATION OF THE LOCATION.

TYPICAL CONDUIT DRAIN AND BREATHER DETAILS NOT TO SCALE

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BOLTON POINT WATER TREATMENT FACILITY
ELECTRICAL UPGRADES

08/31/2025

OCTOBER, 2023

AS SHOWN

Sheet Number E501

Project Number

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		LIGHT FIXTURE SCHEDULE TYPE MANUFACTURER CATALOG NUMBER LUMENS LIGHT COLOR VOLTS WATTS INSTALLATION FINISH / COLOR REMARKS									
			LIGHT FIXT	URE SCH	EDULE						
DESIGNATION	TYPE	MANUFACTURER	CATALOG NUMBER	LUMENS			VOLTS	WATTS	INSTALLATION	FINISH / COLOR	REMARKS
L1	4' LINEAR	HE WILLIAMS	80R-4-L52-840-DIM-UNV	5,200	N/A	4000K	120	37.6	SURFACE	WHITE	
L2	4' LINEAR	HE WILLIAMS	80R-4-L72-840-DIM-UNV	7,200	N/A	4000K	120	54.3	SUSPENDED	WHITE	
L3	4' LINEAR	HE WILLIAMS	80R-4-L72-840-EM/10W-DIM-UNV	7,200	N/A	4000K	120	54.3	SUSPENDED	WHITE	1
E1	EXIT SIGN AND EMERGENCY LIGHT	COOPER	LPXC50SD	N/A	N/A	RED	120	2.2	WALL	WHITE	1, 2
E2	EMERGENCY LIGHT	COOPER	SEL50SD	N/A	N/A	N/A	120	1.2	WALL	WHITE	1, 2
WP1	WALL PACK	DECO	D464-L-42-40-UNV-Z-T-E	4,250	N/A	4000K	120	42	WALL	BRONZE	1, 3
GENERAL NOTE	S, LIGHT FIXTURE SCHEDULE										

- 1. MODEL IS GIVEN FOR QUALITY ONLY, SUBSTITUTE LIGHT FIXTURES SHALL BE OF EQUAL OR GREATER QUALITY.
- 2. ALL FIXTURES TO BE PROVIDED WITH REQUIRED MOUNTING HARDWARE FOR INSTALLATION TYPE SHOWN.
- 1. PROVIDE WITH EMERGENCY BATTERY.
- 2. FIXTURE SHALL BE SELF DIAGNOSTIC.
- 3. PROVIDE WITH INTEGRAL PHOTOCELL.

CIRCUIT SCHEDULE									
DESIGNATION	CONDUCTORS (SETS-QUANTITY#SIZE)	CONDUIT (SETS- DIAMETER)	REMARKS						
1	3#1/0 WITH FULL 100% NEUTRAL, 34.5KV, EPR	1-5"	1						
2	8 SETS OF 4#500, 1#500G	10-5"	2						
3	8 SETS OF 4#500, 1#500G	8-5"							
4	3 SETS OF 4#600M 1#4/0G	4-5"	1						
5	8 SETS OF 4#500, 1#500G	8-5"							
6	3#6, 1#10G	1"							
7	4#2, 1#6G	1 1/2"							
8	4#6, 1#10G	1"							
9	4#2, 1#6G	1 1/2"							
10	4#2, 1#6G	REUSE EXISTING							
11	2#10, 1#10G	3/4"							
12	2#10, 1#10G	REUSE EXISTING							
13	3#400, 1#2G	3"							
14	3#400, 1#2G	REUSE EXISTING							
15	3#2, 1#6G	1 1/2"							
16	4#4, 1#8G	REUSE EXISTING							
17	2#10, 1#10G	3/4"							
18	3#2, 1#6G	1 1/2"							
19	3#2, 1#6G	1 1/2"							
20	3#2, 1#6G	REUSE EXISTING							
21	3#2, 1#6G	1 1/2"							
22	3#2, 1#6G	REUSE EXISTING							
23	3#8, 1#10G	1"							
24	3#8, 1#10G	REUSE EXISTING							
25	3#10, 1#10G	3/4"							
26	3#10, 1#10G	3/4"							
27	3#10, 1#10G	3/4"							
28	3#10, 1#10G	3/4"							
29	3#1/0, 1#6G (1000V, SHIELDED VFD CABLE)	3"							
30	NOT USED	-							
31	2 SETS OF 3#4/0, 1#1/0G	2-2"							
32	2 SETS OF 3#4/0, 1#1/0G	2-2"							
33	3#10, 1#10G	3/4"							
34	3#10, 1#10G	REUSE EXISTING							

CIRCUIT SCHEDULE NOTE

- 1. VERIFY EXISTING CIRCUIT SIZES (WIRE AND CONDUIT) WHERE FEEDING EXISTING LOADS.
- CIRCUIT SCHEDULE REMARKS
- 1. ONE CONDUIT TO BE USED AS SPARE.
- 2. TWO CONDUITS TO BE USED AS SPARE.

CONDUIT SCHEDULE			
BUILDING OR AREA	AREA DESCRIPTION	CONDUIT TYPE	REMARKS
GENERAL (ALL AREAS)	BUILDING INTERIOR	EMT	
	EXTERIOR EXPOSED	RGS	
	RISERS FROM BELOW GRADE	RGS	
	IN SLAB/CONCRETE ENCASEMENT	SCHEDULE 40 PVC	
	SAND-FILL DUCT BANK	SCHEDULE 80 PVC	

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SOUTHERN CAYUGA LAKE INTERMUNICIPAL WATER COMMISSION BOLTON POINT WATER TREATMENT FACILITY ELECTRICAL UPGRADES

OCTOBER, 2023

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